

TP4FOR TOWN PLANNING APPROVALTP3FOR TOWN PLANNING APPROVALTP2FOR TOWN PLANNING APPROVALTP1FOR TOWN PLANNING APPROVALREVAMENDMENTS 12/03/19 11/03/19 08/03/19 01/03/19 DATE



Level 6, 72-80, Cooper St Surry Hills 2010 NSW, Australia





CLIENT

UNIVERSITY OF NEW ENGLAND PROJECT NAME

NEW ROBB COLLEGE


BUILDING NAME

SHEET NAME

SITE PLAN - PROPOSED LOWER GROUND FLOOR

DA-A-03(JI	TP4
	14	
17116	12/03/19	1 : 500 @ A1
PROJECT NO.	REVISION DATE	SCALI
	SC	
REGISTRATION NO.	CHECKED BY	
	SU	N
PROJECT ARCHITECT:	DRAWN BY	

0	5	10	15	20	25 m	@A1
						WA1
1:500						

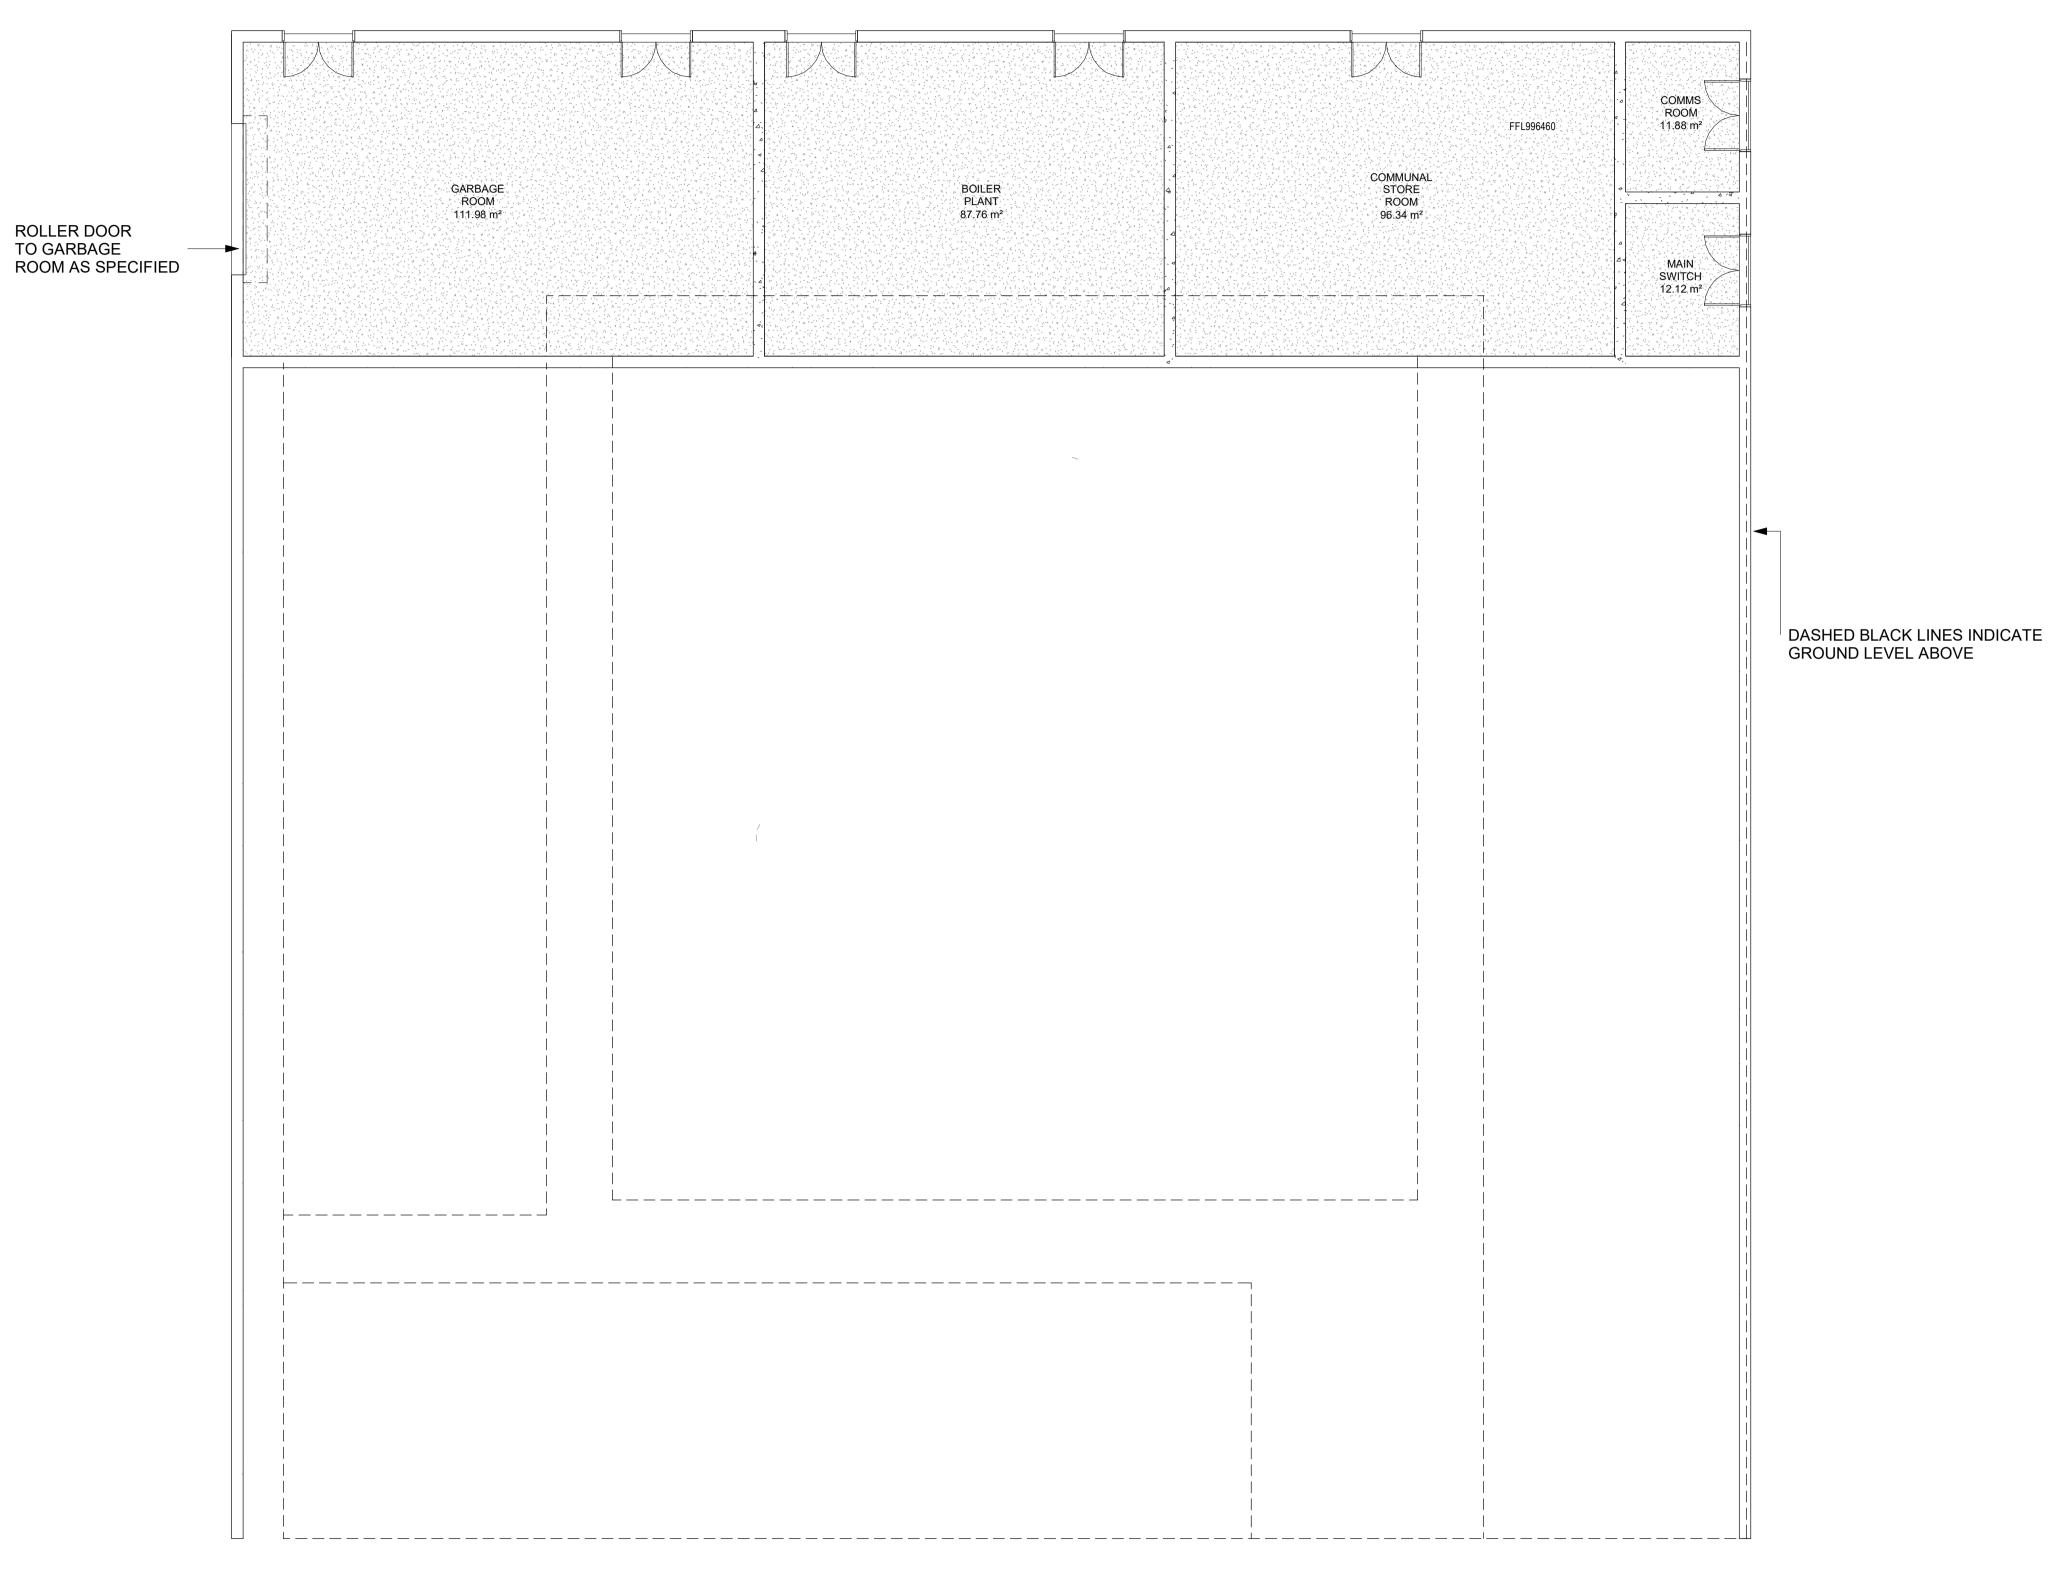

0 1 2 3 4 5 m @A1 DEVELOPMENT APPLICATION

DA-W-10	01	TP3
DRAWING NO		REVISION NUMBER
17116	05/04/19	1 : 100 @ A1
PROJECT NO.	REVISION DATE	SCALE
	SC	
REGISTRATION NO.	CHECKED BY	
	SU	
PROJECT ARCHITECT:	DRAWN BY	

LOWER GROUND WEST PLAN

BUILDING NAME

SHEET NAME

PROJECT NAME NEW ROBB COLLEGE

UNIVERSITY OF NEW ENGLAND




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TP3	FOR TOWN PLANNING APPROVAL	05/04/19
TP2	FOR TOWN PLANNING APPROVAL	08/03/19
TP1	FOR TOWN PLANNING APPROVAL	01/03/19
REV	AMENDMENTS	DATE







APARTMENT / ROOM NUMBERS GROUND FLOOR				
APARTMENT TYPE	NUMBER OF APARTMENTS	NUMBER OF ROOMS		
5 BED ACCESSIBLE APARTMENT	3	15		
5 BED APARTMENT	2	10		
1 BED ACCESSIBLE APARTMENT	1	1		
1 BED APARTMENT	3	3		
TOTAL NUMBER OF ROOMS ON GROUND FLOOR: 29				

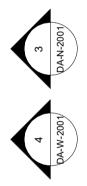TP5	FOR TOWN PLANNING APPROVAL	08/04/19
TP4	FOR TOWN PLANNING APPROVAL	05/04/19
TP3	FOR TOWN PLANNING APPROVAL	12/03/19
TP2	FOR TOWN PLANNING APPROVAL	08/03/19
TP1	FOR TOWN PLANNING APPROVAL	01/03/19
REV	AMENDMENTS	DATE



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UNIVERSITY OF NEW ENGLAND PROJECT NAME


NEW ROBB COLLEGE

BUILDING NAME

SHEET NAME **TYPICAL COURT - GROUND** FLOOR GA PLAN

DA-N-100)1	TP5
DRAWING NO		REVISION NUMBER
17116	08/04/19	1 : 100 @ A1
PROJECT NO.	REVISION DATE	SCALE
	Checker	
REGISTRATION NO.	CHECKED BY	
	Author	
PROJECT ARCHITECT:	DRAWN BY	

0 1 2 3 4 5 m @A1 DEVELOPMENT APPLICATION

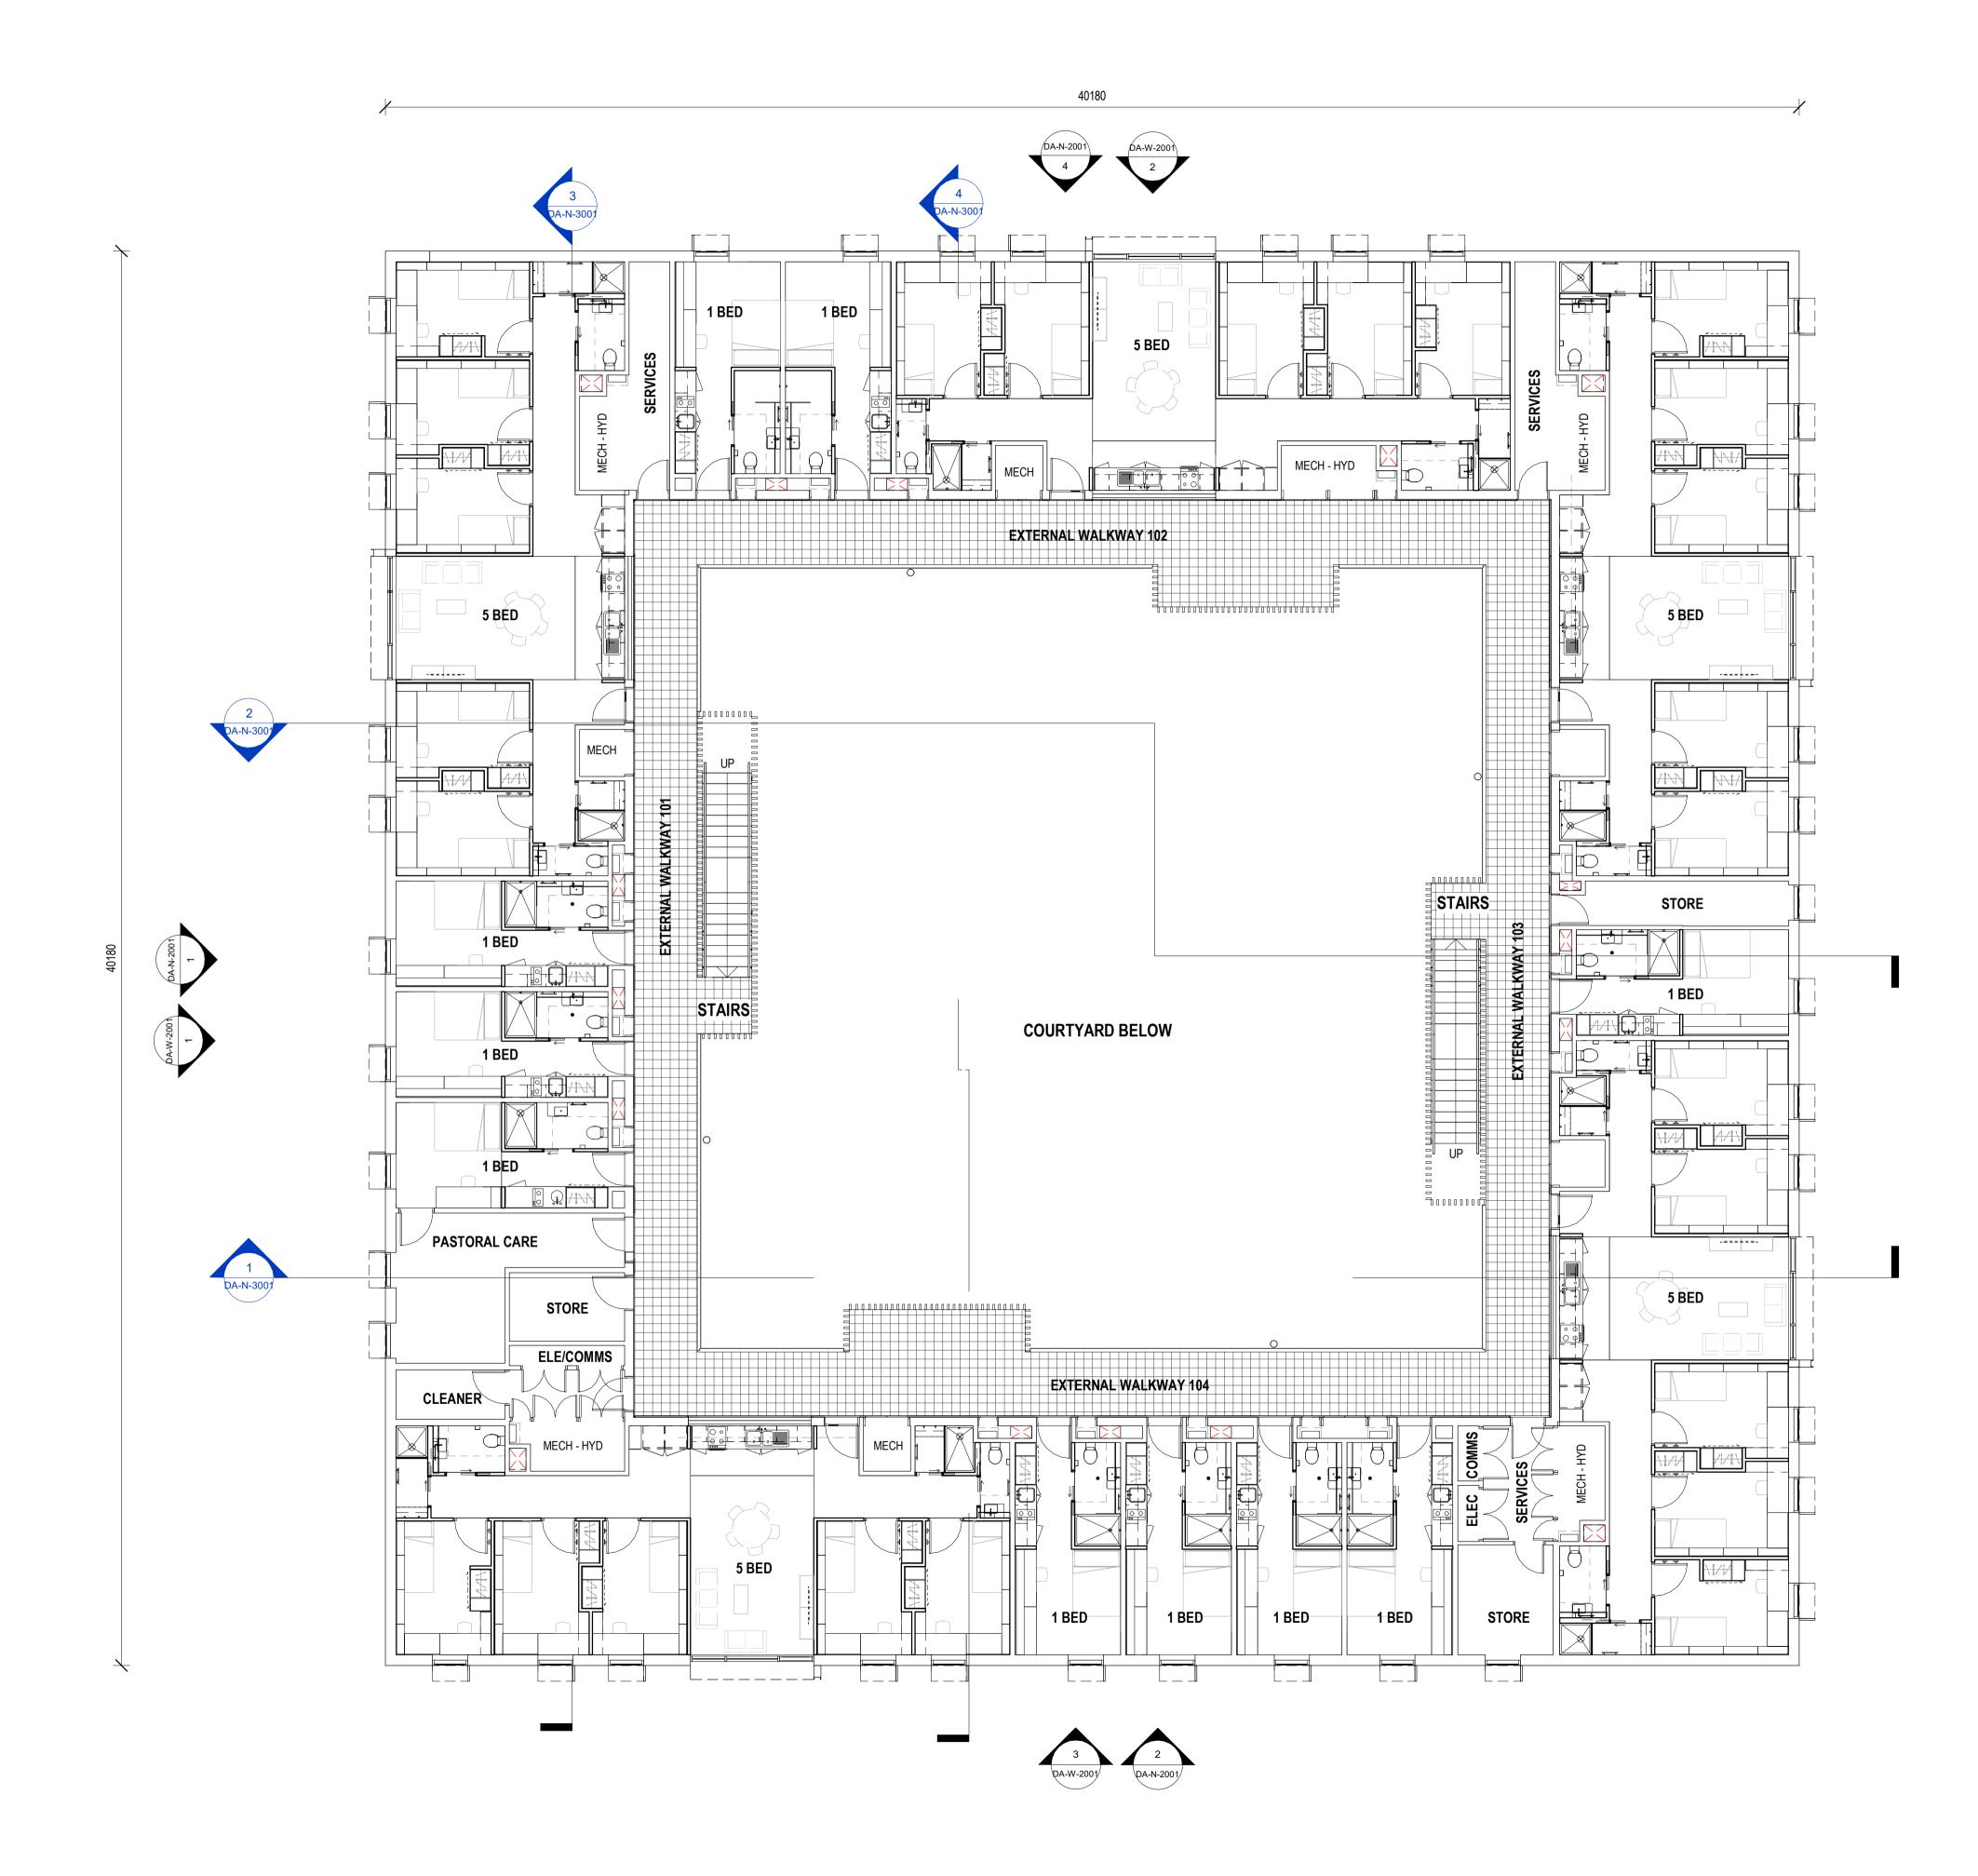



4 0A-W-200

APARTMENT / ROOM NUMBERS - LEVEL 1				
APARTMENT TYPE	NUMBER OF APARTMENTS	NUMBER OF ROOMS		
5 BED ACCESSIBLE APARTMENT	0	0		
5 BED APARTMENT	5	25		
1 BED ACCESSIBLE APARTMENT	0	1		
1 BED APARTMENT	10	10		
TOTAL NUMBER OF ROOMS ON FIRST FLOOR: 35				

TP5	FOR TOWN PLANNING APPROVAL	08/04/19
TP4	FOR TOWN PLANNING APPROVAL	05/04/19
TP3	FOR TOWN PLANNING APPROVAL	12/03/19
TP2	FOR TOWN PLANNING APPROVAL	08/03/19
TP1	FOR TOWN PLANNING APPROVAL	01/03/19
REV	AMENDMENTS	DATE



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UNIVERSITY OF NEW ENGLAND PROJECT NAME

NEW ROBB COLLEGE

BUILDING NAME


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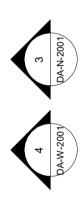
TYPICAL COURT - LEVEL 1 GA PLAN

PROJECT ARCHITECT: DRAWN BY SU REGISTRATION NO. CHECKED BY SC PROJECT NO. REVISION DATE SCALE 17116 08/04/19 1 : 100 @ A1 DRAWING NO REVISION NUMBER DA-N-1002 TP5

0 1 2 3 4 ^{5 m} @A1 1:100

DEVELOPMENT APPLICATION



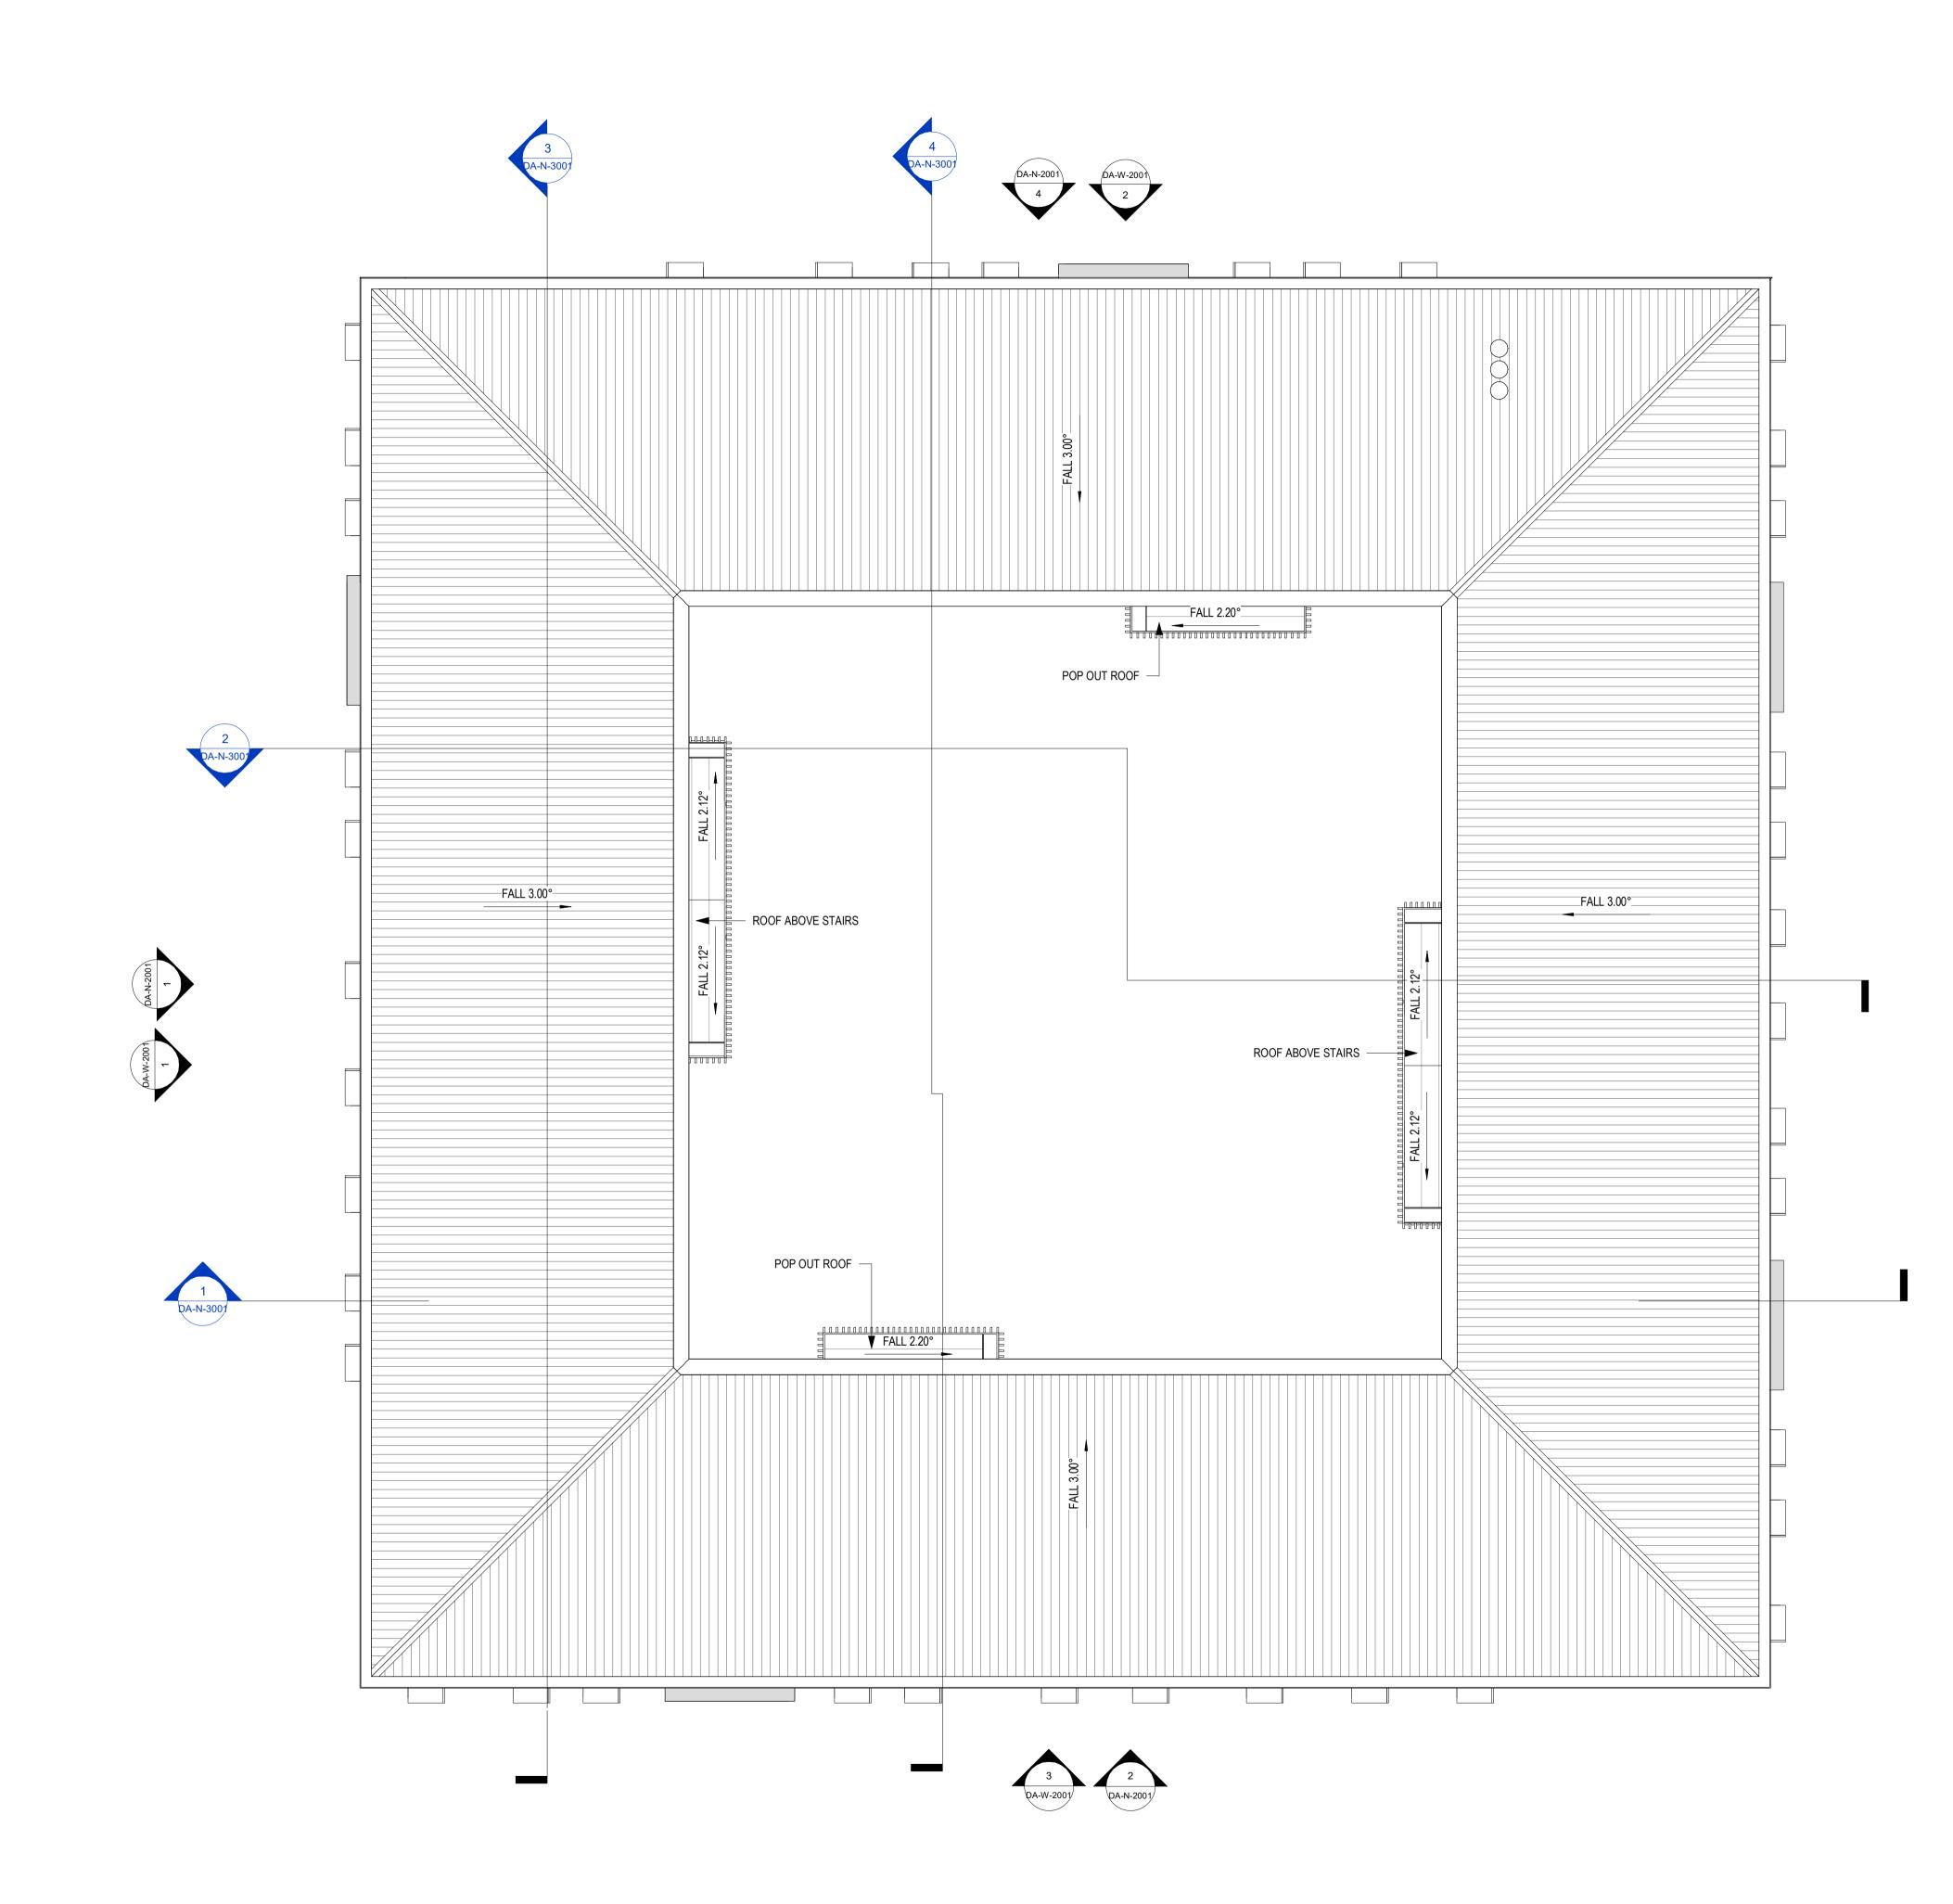

_____ TP4FOR TOWN PLANNING APPROVALTP3FOR TOWN PLANNING APPROVALTP2FOR TOWN PLANNING APPROVALTP1FOR TOWN PLANNING APPROVALREVAMENDMENTS 08/04/19 05/04/19 08/03/19 01/03/19 DATE



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UNIVERSITY OF NEW ENGLAND PROJECT NAME


NEW ROBB COLLEGE

BUILDING NAME

SHEET NAME **TYPICAL COURT - ROOF GA** PLAN

DA-N-100	3	TP4
DRAWING NO	11	REVISION NUMBER
17116	08/04/19	1 : 100 @ A1
PROJECT NO.	REVISION DATE	SCALE
	Checker	
REGISTRATION NO.	CHECKED BY	
	Author	
PROJECT ARCHITECT:	DRAWN BY	

0 1 2 3 4 5 m @A1 DEVELOPMENT APPLICATION

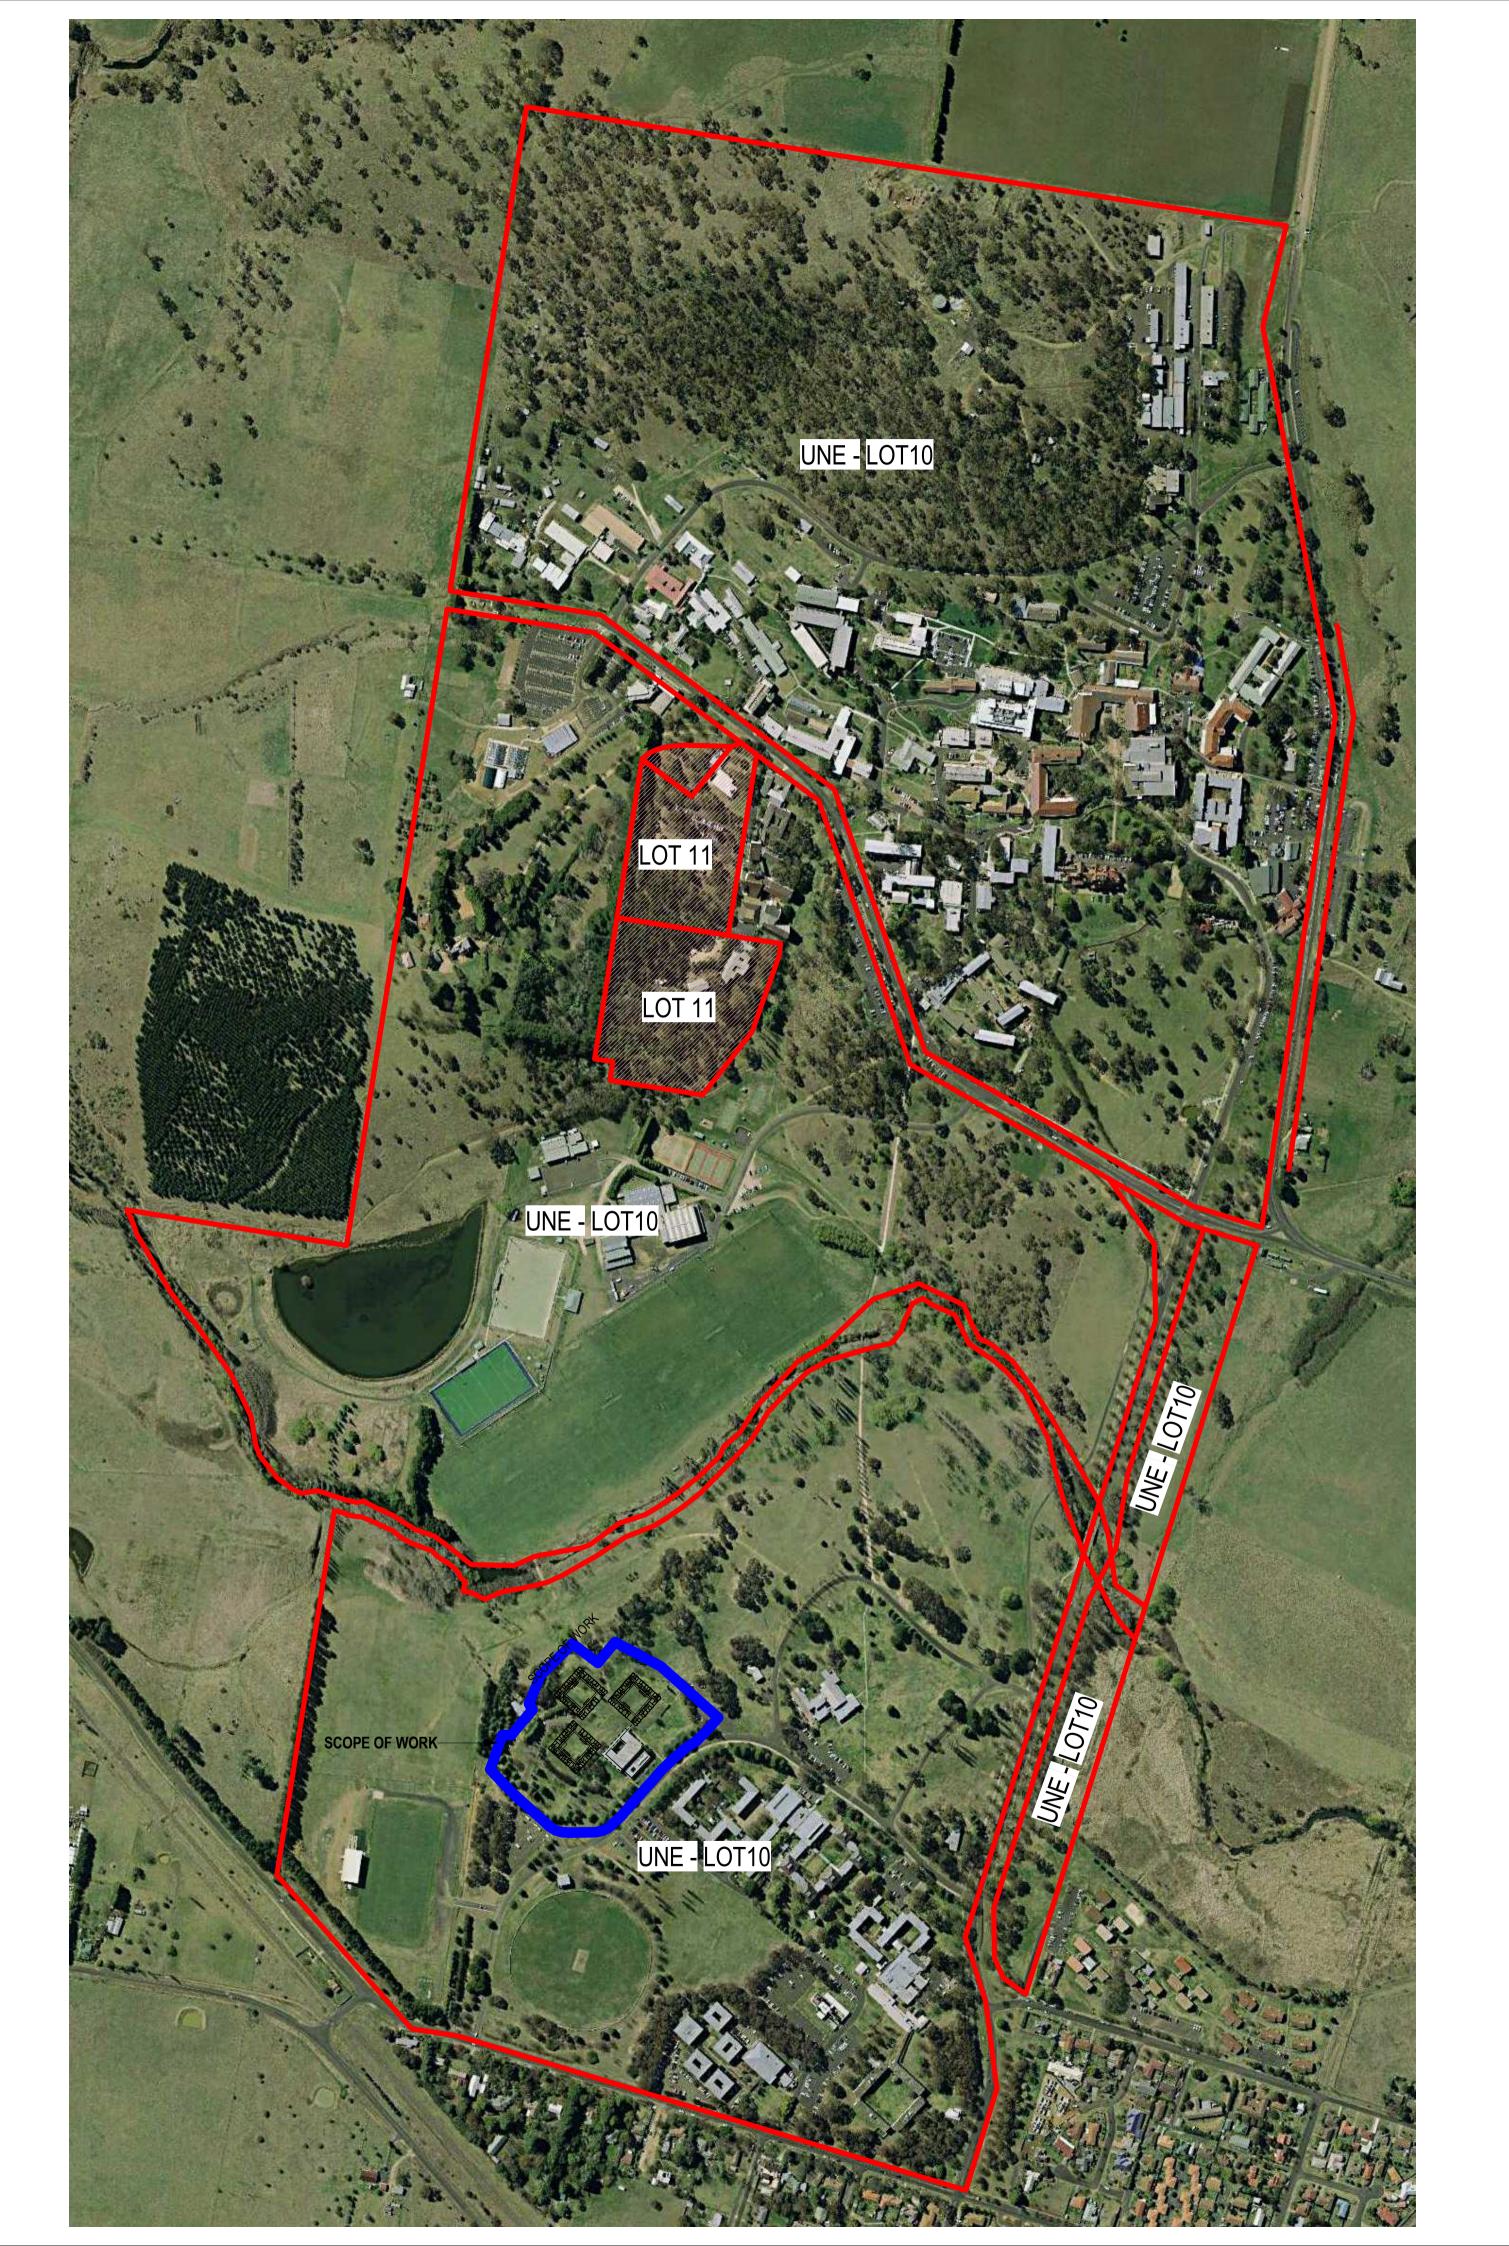

SITE BOUNDARY

SCOPE OF WORK

TP3	FOR TOWN PLANNING APPROVAL	11/03/19
TP2	FOR TOWN PLANNING APPROVAL	08/03/19
TP1	FOR TOWN PLANNING APPROVAL	01/03/19
REV	AMENDMENTS	DATE



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CLIENT

UNIVERSITY OF NEW ENGLAND

PROJECT NAME NEW ROBB COLLEGE


BUILDING NAME

SHEET NAME OVERALL SITE PLAN -NEIGHBOURING BUILDINGS & BOUNDARY


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PROJECT NO.	REVISION DATE		SCALE
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REGISTRATION NO.	CHECKED BY		
	Author		
PROJECT ARCHITECT:	DRAWN BY		


DEVELOPMENT APPLICATION


 TOP OF PARAPET RL 1007.300 TOP OF STEEL RL 1006.000 LEVEL 1 RL 1002.700 GROUND FLOOR RL 999.500 			
	1 WEST COURT - SOUTH EAST ELEVATION 1 : 100		
 TOP OF PARAPET RL 1007.300 TOP OF STEEL RL 1006.000 LEVEL 1 RL 1002.700 GROUND FLOOR RL 999.500 LOWER GROUND FLOOR RL 996.400 			
 TOP OF PARAPET RL 1007.300 TOP OF STEEL RL 1006.000 LEVEL 1 RL 1002.700 GROUND FLOOR RL 999.500 LOWER GROUND FLOOR RL 996.400 			
 TOP OF PARAPET RL 1007.300 TOP OF STEEL RL 1006.000 LEVEL 1 RL 1002.700 GROUND FLOOR RL 999.500 	3 WEST COURT - NORTH WEST ELEVATION 1:100 CD-02 CD-01 CD-01 CD-01 CD-01 CD-01 CD-01 CD-01 CD-01 CD-01	-03 LV-01 GL-01 GL-01	CD-01 CD-01 CD-01
LOWER GROUND FLOOR RL 996.400	4 WEST COURT - SOUTH WEST ELEVATION 1:100		

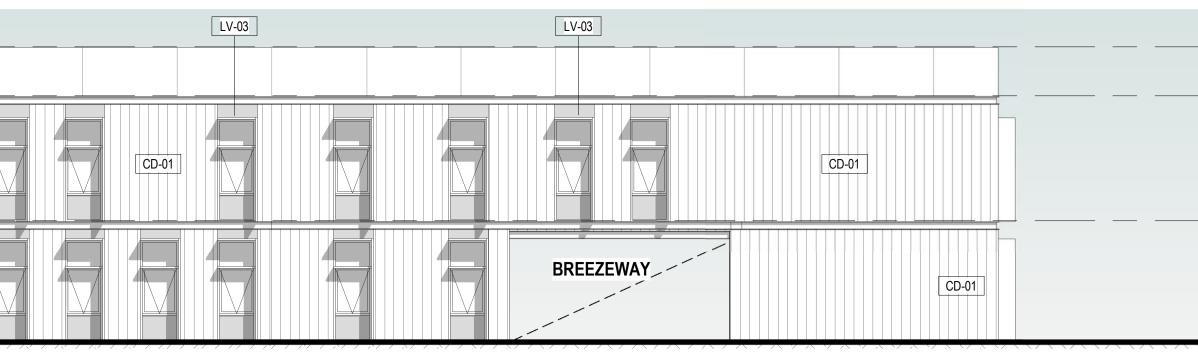



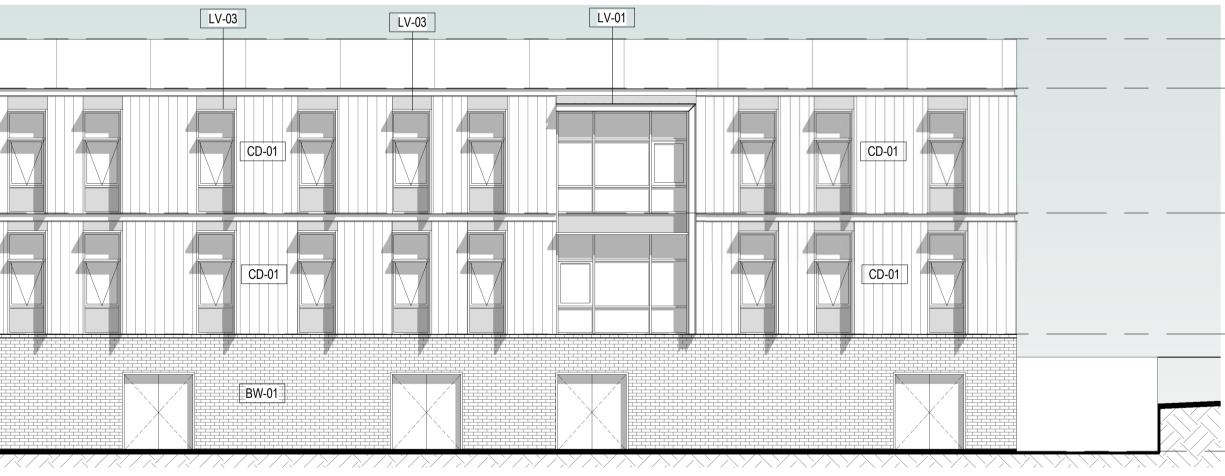

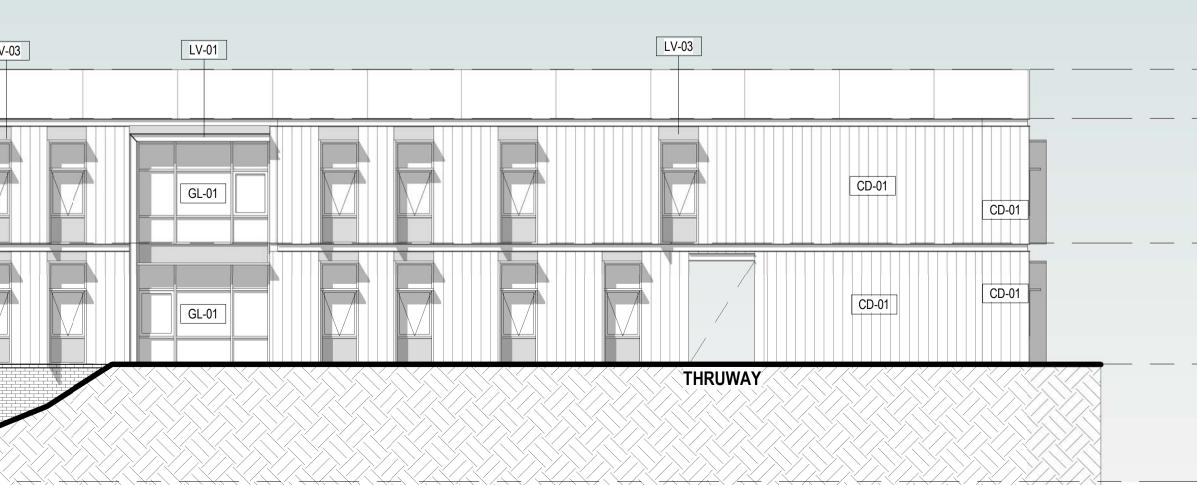

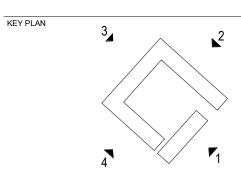

KEY PLAN: NOT TO SCALE

KEYNOTE LEGEND			
Key Value Discription			
BW-01	Brickwork		
CD-01	Metal Cladding 1		
CD-02	Metal Cladding 2		
GL-01	Vision Panel		
LV-01	Window Louvre #1		
LV-03	Window Louvre #3		

TP5	FOR TOWN PLANNING APPROVAL	08/04/19
TP4	FOR TOWN PLANNING APPROVAL	05/04/19
TP3	FOR TOWN PLANNING APPROVAL	12/03/19
TP2	FOR TOWN PLANNING APPROVAL	11/03/19
TP1	FOR TOWN PLANNING APPROVAL	01/03/19

TP5	FOR TOWN PLANNING APPROVAL	08/04/19
TP4	FOR TOWN PLANNING APPROVAL	05/04/19
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TP1	FOR TOWN PLANNING APPROVAL	01/03/19
DEV		DATE

P5	FOR TOWN PLANNING APPROVAL	08/04/19	
P4	FOR TOWN PLANNING APPROVAL	05/04/19	
P3	FOR TOWN PLANNING APPROVAL	12/03/19	
P2	FOR TOWN PLANNING APPROVAL 11/0		
P1	FOR TOWN PLANNING APPROVAL	01/03/19	
REV	AMENDMENTS	DATE	
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0090 4000

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PROJECT NAME NEW ROBB COLLEGE

UNIVERSITY OF NEW ENGLAND

WEST COURT ELEVATIONS



BUILDING NAME

SHEET NAME

17116

DRAWING NO

0 1 2 3 4 ⁵ m **@A1** 1:100


DA-W-2001

SCALE

08/04/19 1 : 100 @ A1


REVISION NUMBER

TP5

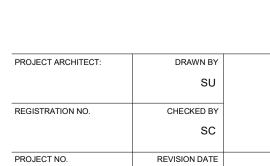

DEVELOPMENT APPLICATION



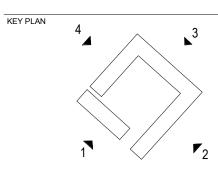

KEY PLAN: NOT TO SCALE

KEYNOTE LEGEND			
Key Value Discription			
CD-01	Metal Cladding 1		
CD-02	Metal Cladding 2		
GL-01	Vision Panel		
LV-01	Window Louvre #1		
LV-03	Window Louvre #3		

TP6	FOR TOWN PLANNING APPROVAL	08/04/19
TP5	FOR TOWN PLANNING APPROVAL	05/04/19
TP4	FOR TOWN PLANNING APPROVAL	12/03/19
TP3	FOR TOWN PLANNING	11/03/19
TP2	FOR TOWN PLANNING APPROVAL	08/03/19
TP1	FOR TOWN PLANNING APPROVAL	01/03/19
REV	AMENDMENTS	DATE



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CLIENT





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NORTH COURT ELEVATIONS

DRAWN BY

CHECKED BY SC

REVISION DATE

HR

SHEET NAME

PROJECT ARCHITECT:

REGISTRATION NO.

PROJECT NO.

17116

DRAWING NO

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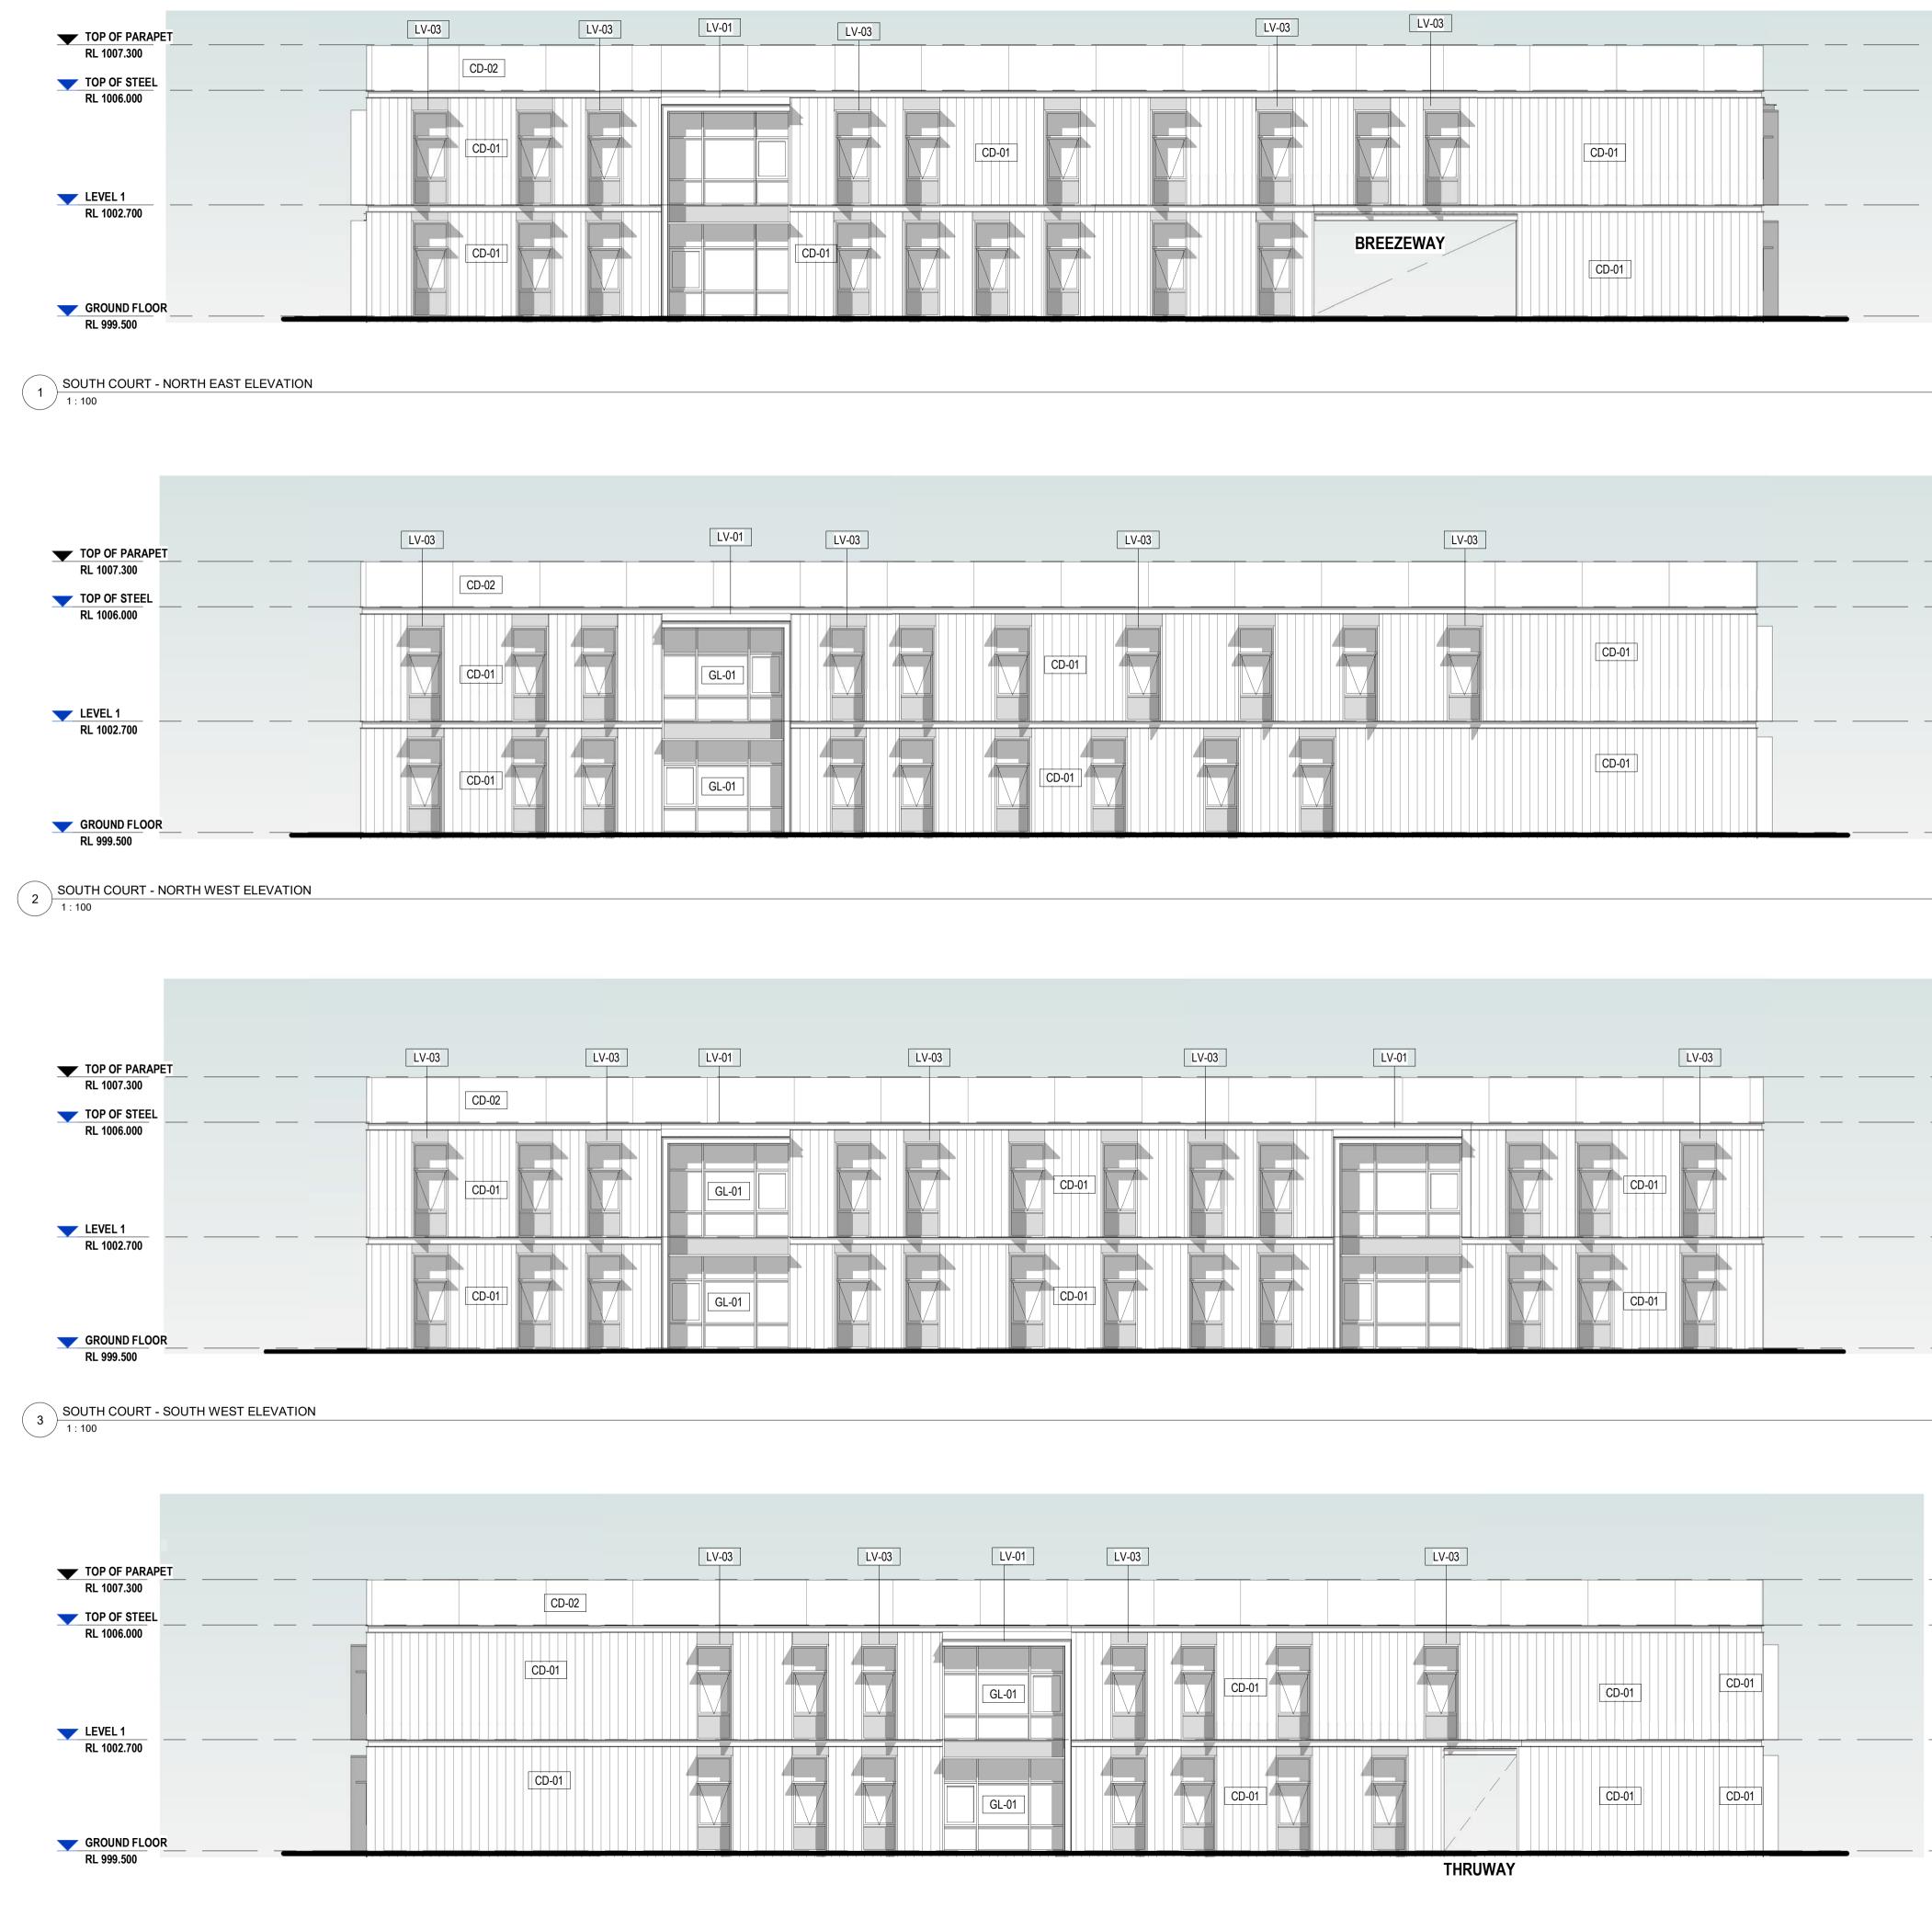
DA-N-2001

BUILDING NAME

PROJECT NAME


UNIVERSITY OF NEW ENGLAND

NEW ROBB COLLEGE



4 SOUTH COURT - SOUTH EAST ELEVATION 1:100

	LV-03	LV-03	LV-03		
	CD-01			CD-01	
-01		BR	EEZEWAY	CD-01	

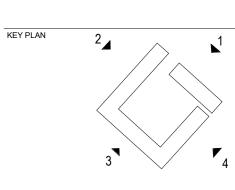

KEY PLAN: NOT TO SCALE

Keynote Legend			
Key Value Keynote Text			
CD-01	Metal Cladding 1		
CD-02	Metal Cladding 2		
GL-01 Vision Panel			
LV-01	Window Louvre #1		
LV-03	Window Louvre #3		

TP2	FOR TOWN PLANNING APPROVAL	08/04/19
TP1	FOR TOWN PLANNING APPROVAL	05/04/19

TP2	FOR TOWN PLANNING APPROVAL	08/04/19
TP1	FOR TOWN PLANNING APPROVAL	05/04/19
REV	AMENDMENTS	DATE



CLIENT

PROJECT NAME

BUILDING NAME

PROJECT ARCHITECT:

REGISTRATION NO.

PROJECT NO.

17116

DRAWING NO

0 20 40 60 80 100 m @A1 1:2000

DA-S-2001

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SCALE

SHEET NAME

UNIVERSITY OF NEW ENGLAND

SOUTH COURT ELEVATIONS

SOUTH COURT

DRAWN BY

CHECKED BY

REVISION DATE

DEVELOPMENT APPLICATION

HR


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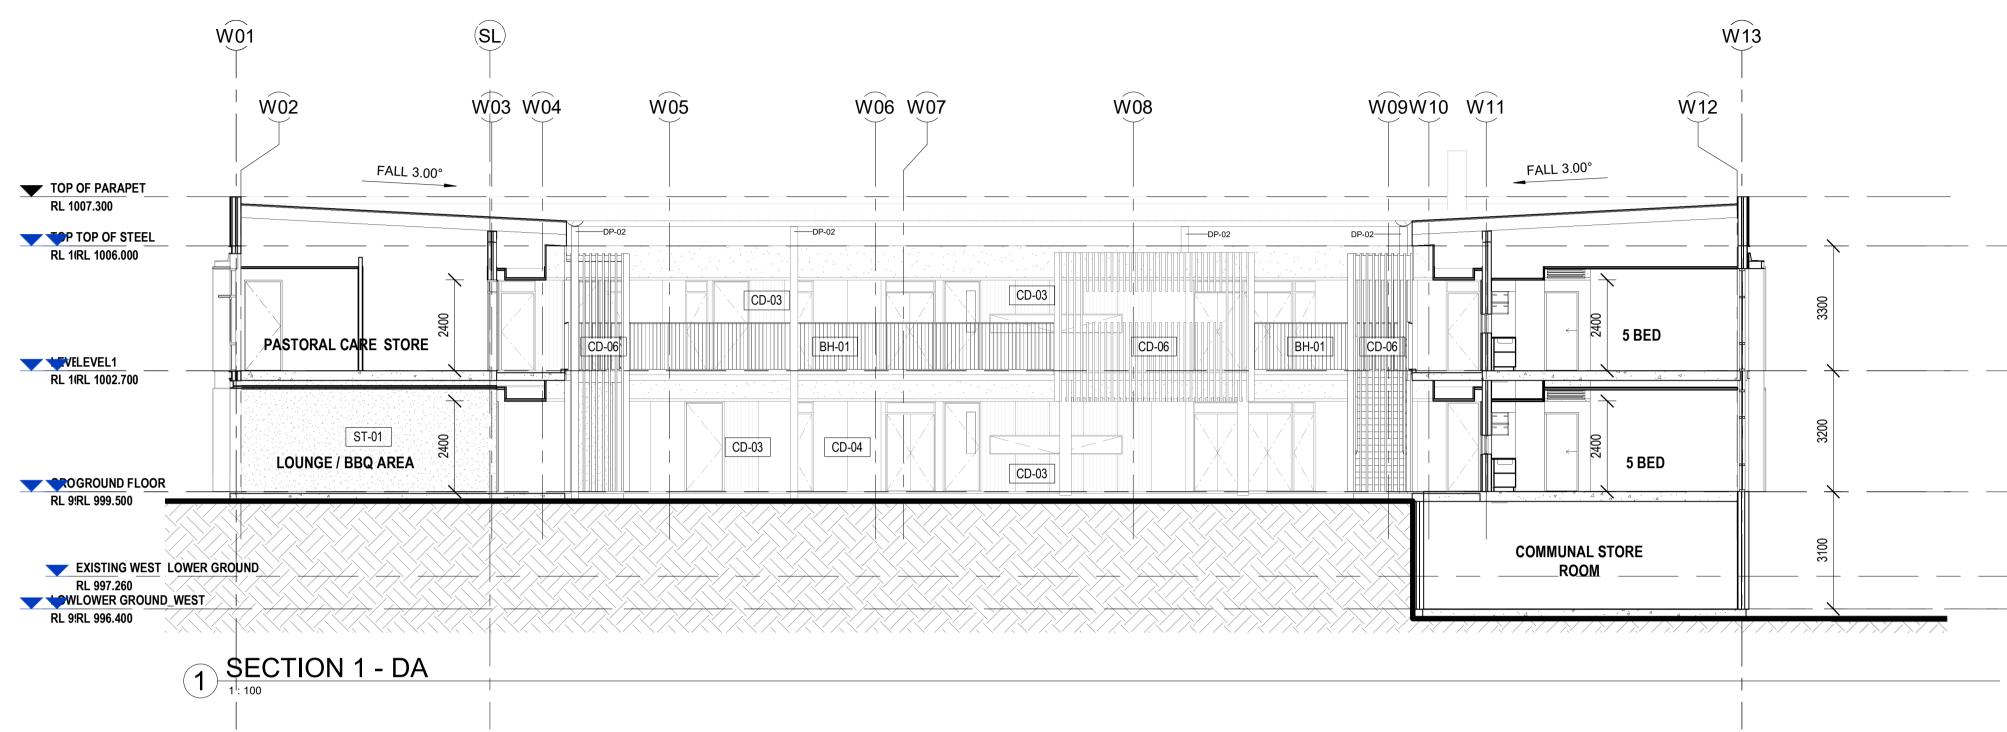
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REVISION NUMBER

TP2

NEW ROBB COLLEGE



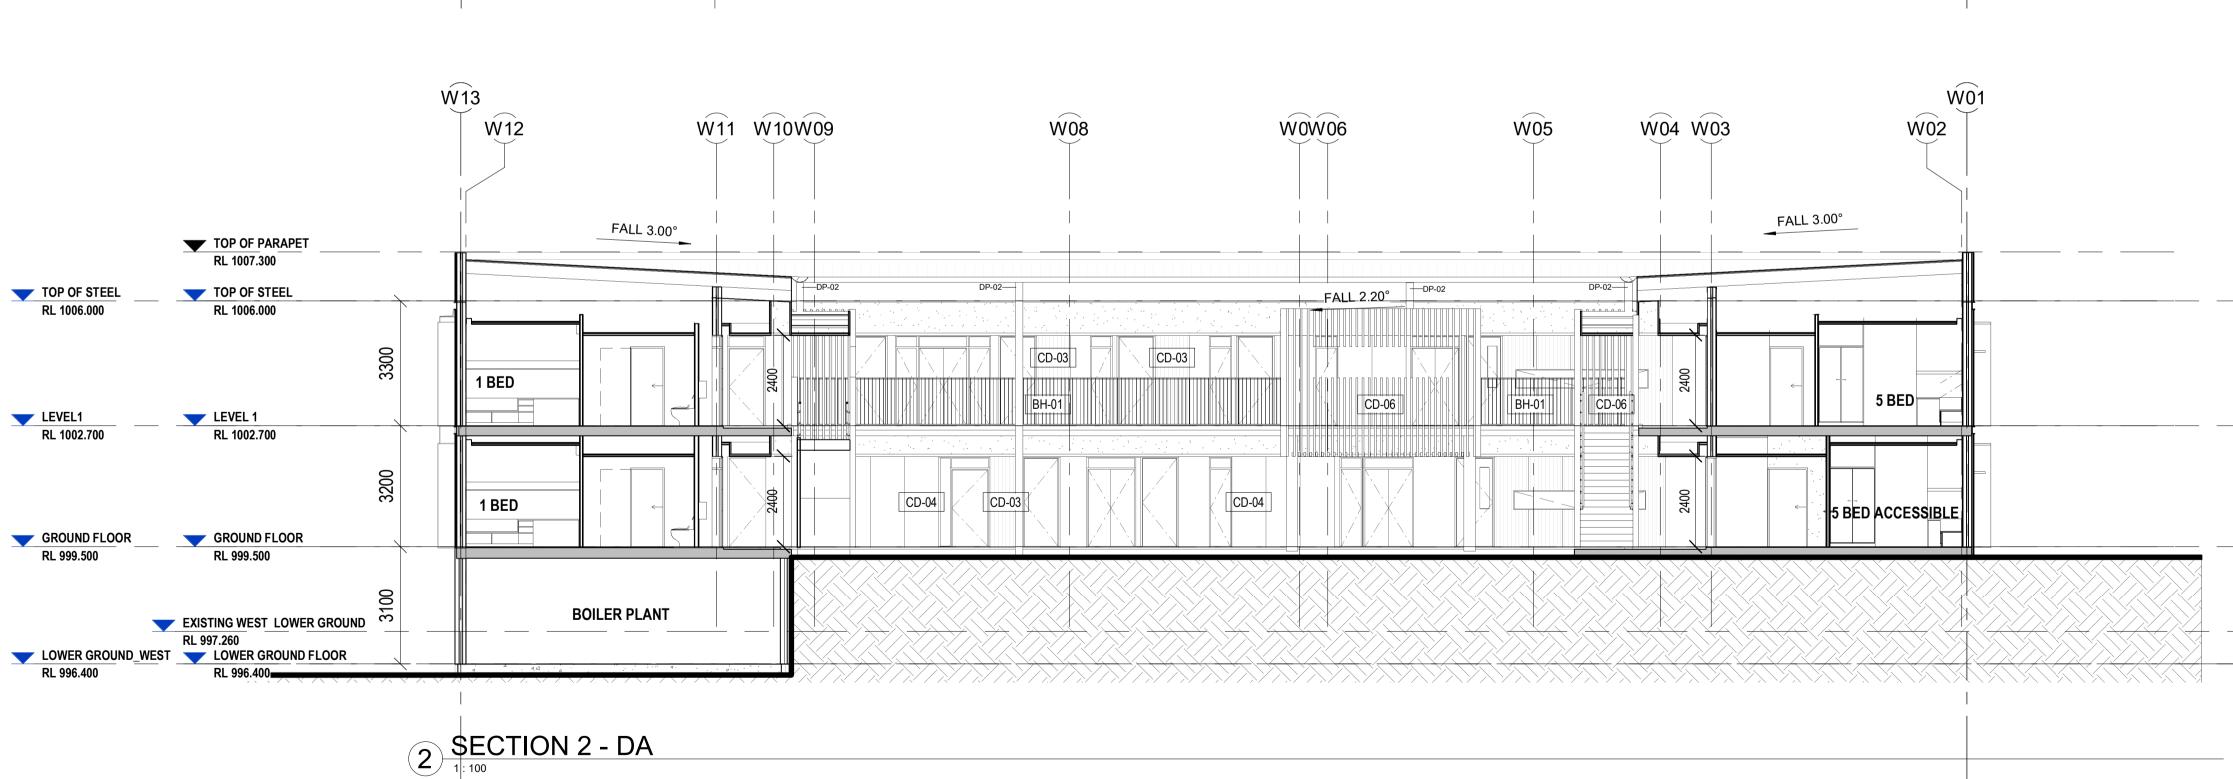

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DEVELOPMENT APPLICATION

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DRAWING NO	1	REVISION NUMBER
17116	08/04/19	1 : 100 @ A1
PROJECT NO.	REVISION DATE	SCALE
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REGISTRATION NO.	CHECKED BY	
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PROJECT ARCHITECT:	DRAWN BY	

WEST COURT SECTIONS

SHEET NAME

BUILDING NAME

NEW ROBB COLLEGE

PROJECT NAME


UNIVERSITY OF NEW ENGLAND




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TP5	FOR TOWN PLANNING APPROVAL	08/04/19
TP4	FOR TOWN PLANNING APPROVAL	05/04/19
TP3	FOR TOWN PLANNING APPROVAL	12/03/19
TP2	FOR TOWN PLANNING APPROVAL	11/03/19
TP1	FOR TOWN PLANNING APPROVAL	01/03/19
REV	AMENDMENTS	DATE




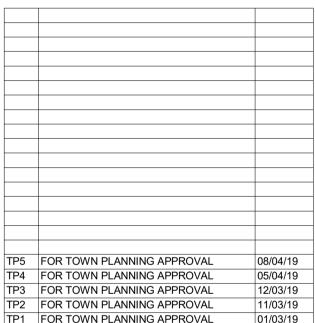



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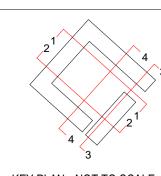
KEY PLAN: NOT TO SCALE

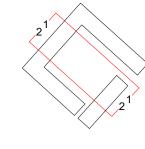KEYNOTE LEGEND		
Key Value	Discription	
BH-01	Custom Balustrades	
CD-03	Metal Cladding 3	
CD-04	Metal Cladding 4	
CD-06	Batten Screen	
ST-01	Stone	



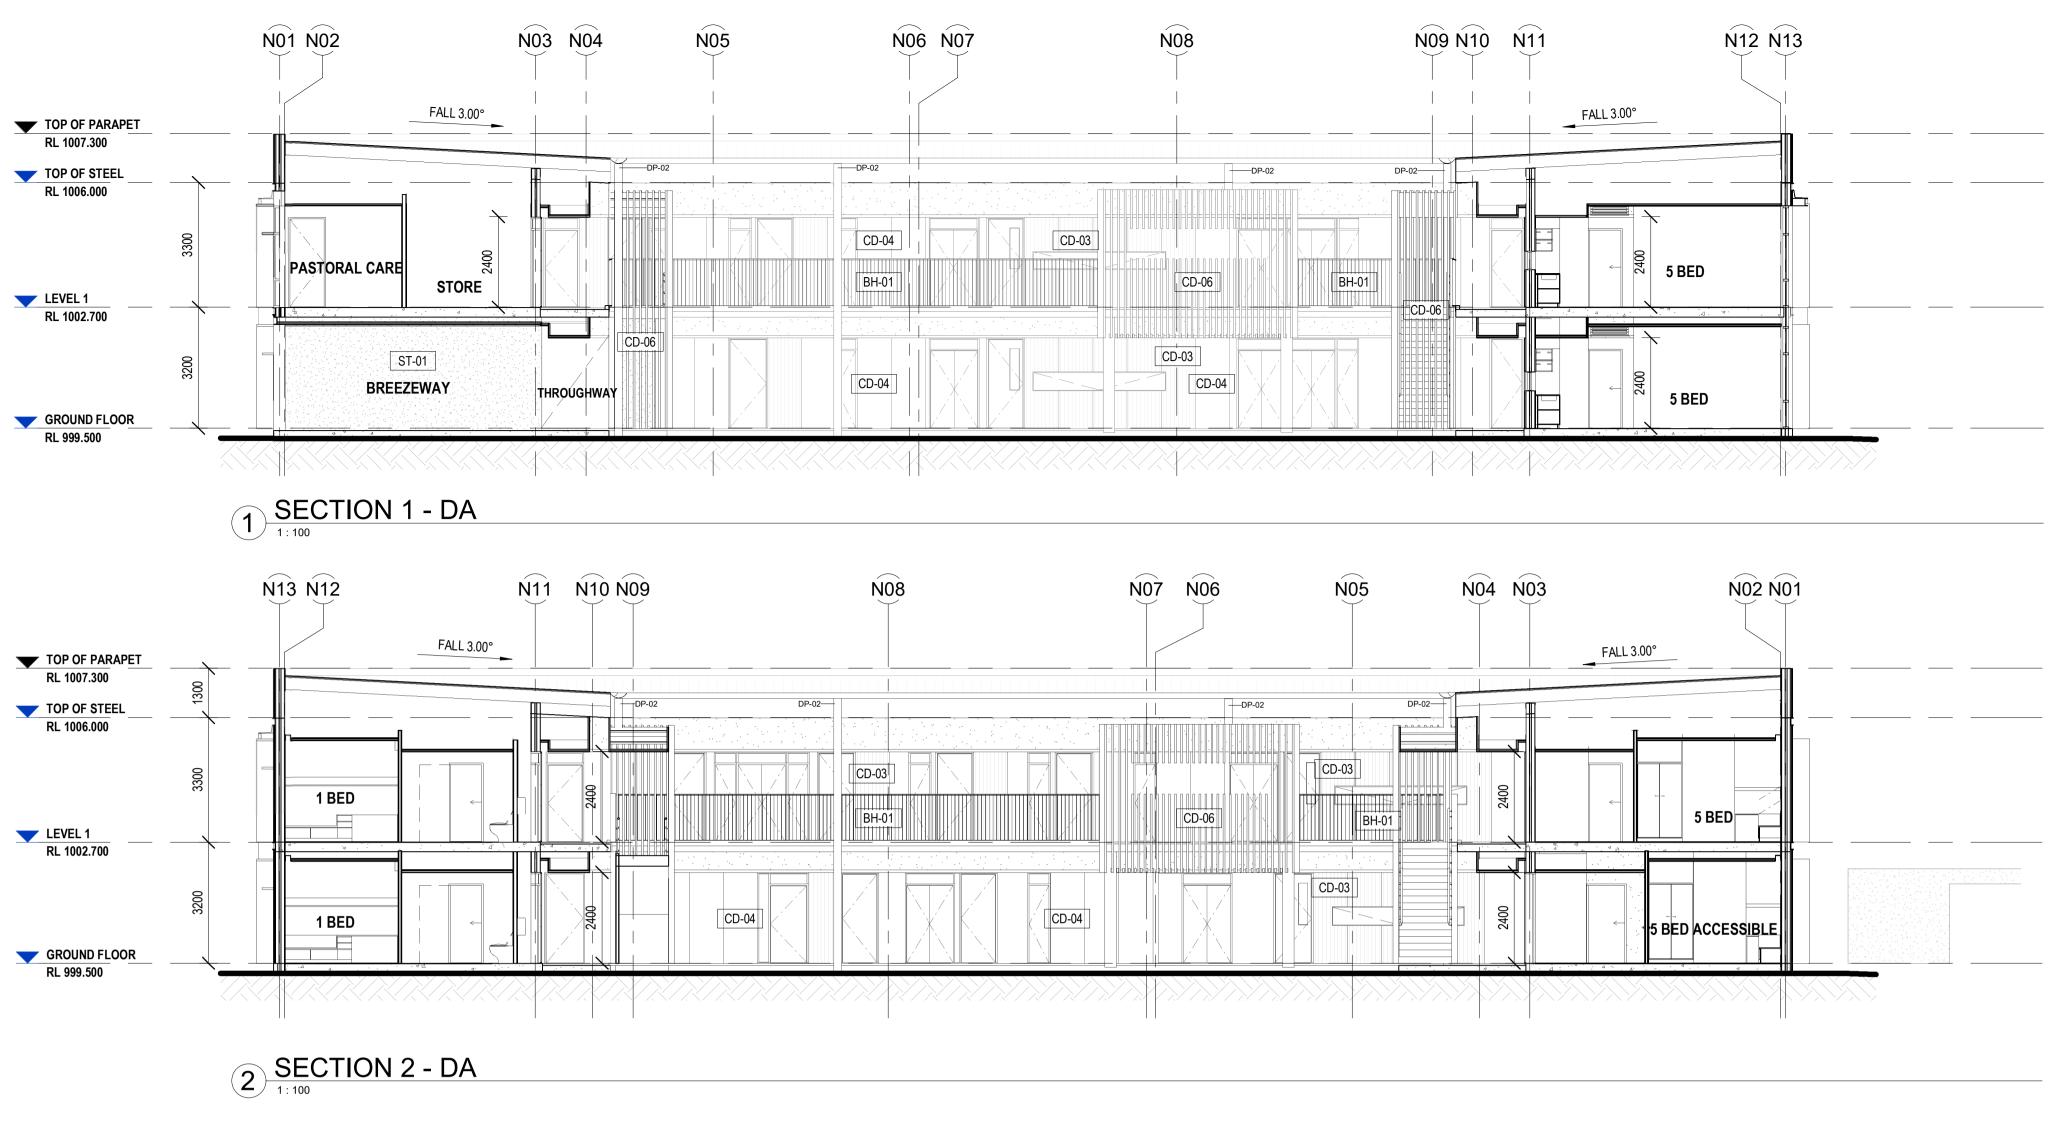

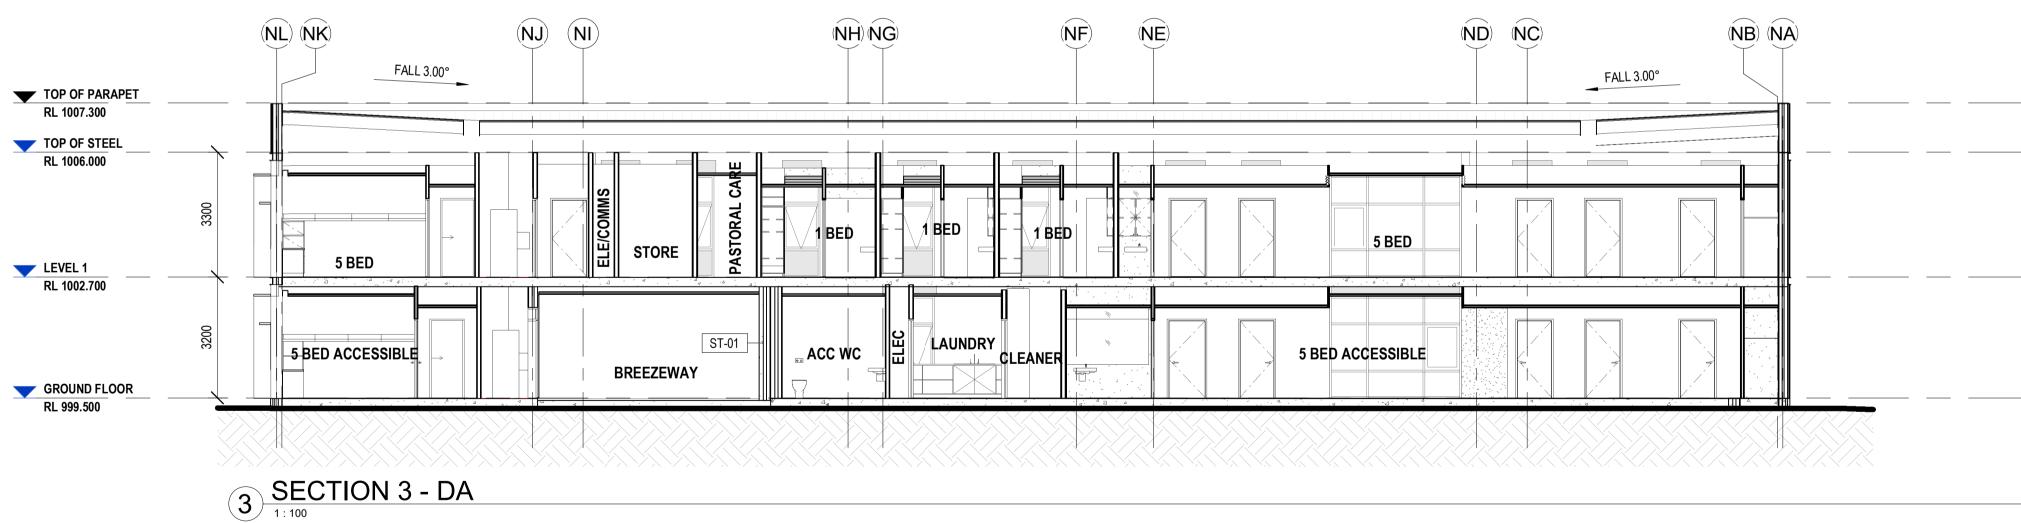

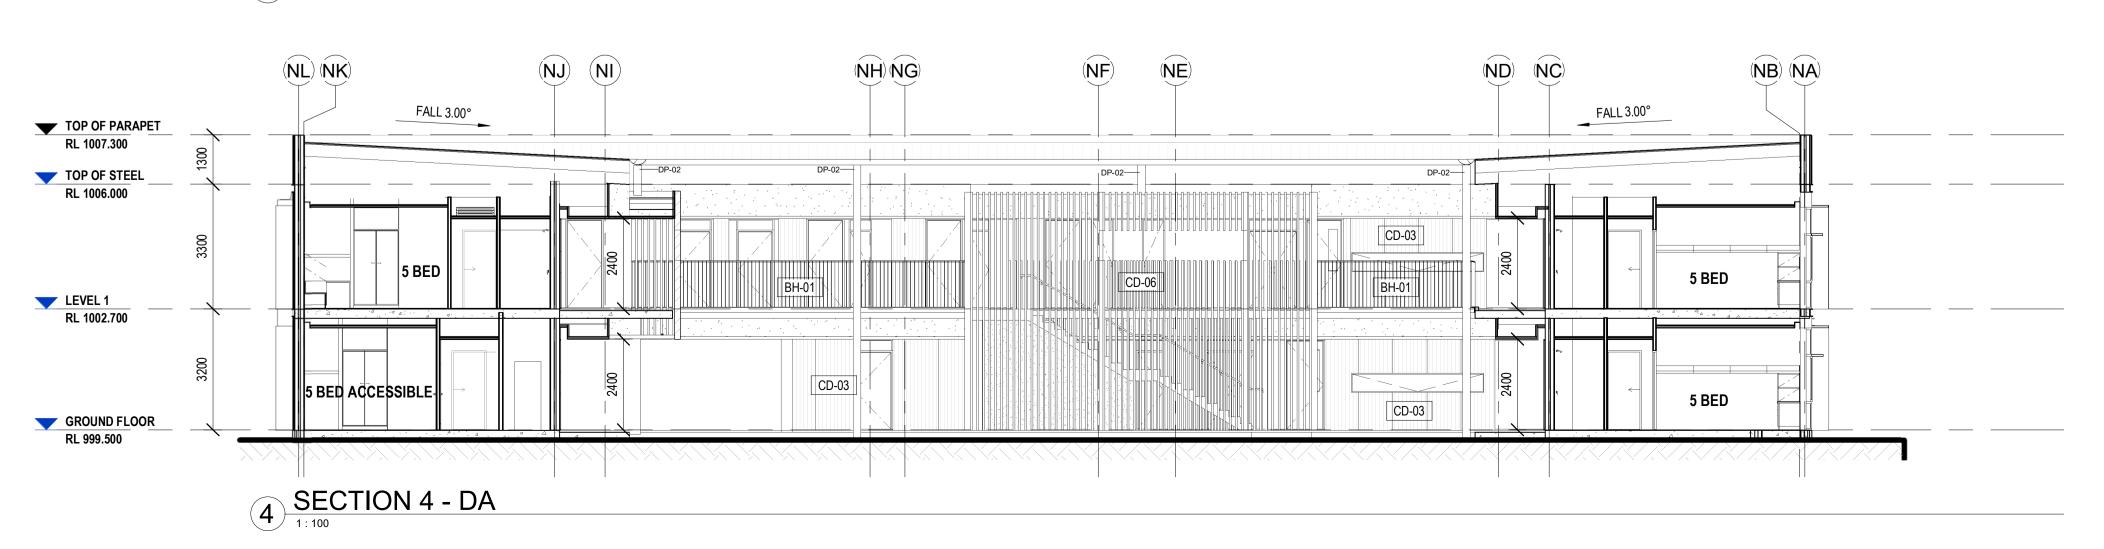

KEY PLAN

KEY PLAN: NOT TO SCALE

KEYNOTE LEGEND		
Key Value	Discription	
BH-01	Custom Balustrades	
CD-03	Metal Cladding 3	
CD-04	Metal Cladding 4	
CD-06	Batten Screen	
ST-01	Stone	

SECTION 3 & 4 ARE TYPICAL TO NORTH/WEST/SOUTH COURTS

TP6	FOR TOWN PLANNING APPROVAL	08/04/19
TP5	FOR TOWN PLANNING APPROVAL	05/04/19
TP4	FOR TOWN PLANNING APPROVAL	12/03/19
TP3	FOR TOWN PLANNING	11/03/19
TP2	FOR TOWN PLANNING APPROVAL	08/03/19
TP1	FOR TOWN PLANNING APPROVAL	01/03/19
REV	AMENDMENTS	DATE



Level 6, 72-80, Cooper St Surry Hills 2010 NSW, Australia













SECTIONS

SHEET NAME

PROJECT ARCHITECT:

REGISTRATION NO.

PROJECT NO.

17116

DRAWING NO

DA-N-3001

BUILDING NAME

NEW ROBB COLLEGE

PROJECT NAME

CLIENT



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DRAWN BY

CHECKED BY SC

REVISION DATE

DEVELOPMENT APPLICATION

SU

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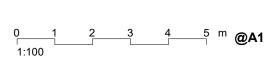




SCALE 08/04/19 1 : 100 @ A1

REVISION NUMBER

TP6





REVISION NUMBER

TP4

12/03/19

11/03/19 08/03/19 01/03/19 DATE

Level 6, 72-80, Cooper St Surry Hills 2010 NSW, Australia

NEW ROBB COLLEGE BUILDING NAME SHEET NAME SITE PLAN - PROPOSED **GROUND FLOOR** PROJECT ARCHITECT: DRAWN BY HR REGISTRATION NO. CHECKED BY SC PROJECT NO. REVISION DATE SCALE 17116 12/03/19 1 : 500 @ A1

DEVELOPMENT APPLICATION

DRAWING NO

0 5 10 15 20 25 m **@A1** 1:500

DA-A-0302

PROJECT NAME

UNIVERSITY OF NEW ENGLAND

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PartnershipE info@blp.com.auwww.blp.com.au

TP4FOR TOWN PLANNING APPROVALTP3FOR TOWN PLANNING APPROVALTP2FOR TOWN PLANNING APPROVALTP1FOR TOWN PLANNING APPROVALREVAMENDMENTS

CLIENT



12/03/19

11/03/19 08/03/19 01/03/19 DATE

Level 6, 72-80, Cooper St Surry Hills 2010 NSW, Australia T+61 2 8096 4066Billard Leece
PartnershipE info@blp.com.auwww.blp.com.au CLIENT UNIVERSITY OF NEW ENGLAND PROJECT NAME NEW ROBB COLLEGE BUILDING NAME SHEET NAME SITE PLAN - PROPOSED **FIRST FLOOR**

TP4FOR TOWN PLANNING APPROVALTP3FOR TOWN PLANNING APPROVALTP2FOR TOWN PLANNING APPROVALTP1FOR TOWN PLANNING APPROVALREVAMENDMENTS

PROJECT ARCHITECT: DRAWN BY SU REGISTRATION NO. CHECKED BY SC PROJECT NO. REVISION DATE SCALE 17116 12/03/19 1 : 500 @ A1 DRAWING NO REVISION NUMBER DA-A-0303 TP4


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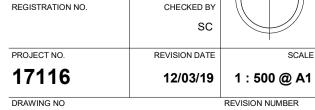
DEVELOPMENT APPLICATION



SCALE

TP4



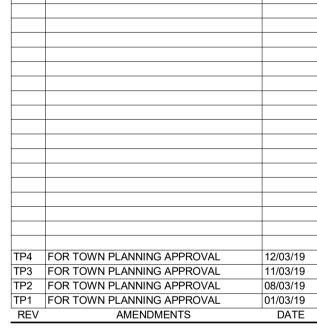

DRAWING NO DA-A-0304

CLIENT

PROJECT NAME

BUILDING NAME

SHEET NAME

ROOF PLAN

PROJECT ARCHITECT:

NEW ROBB COLLEGE

0 5 10 15 20 25 m **@A1** 1:500

DEVELOPMENT APPLICATION

DRAWN BY SU



ST-01 FEATURE STONE WALL CLADDING BASALT CD - 01 METAL CLADDING COLOUR IRONSTONE CD - 02 METAL CLADDING COLOUR WHITEHAVEN CD - 07 PFC TRIM COLOUR WHITEHAVEN


BW - 01 ARCHITECTURAL BRICKWORK LV - 03 WINDOW HOODS #2 COLOUR MONUMENT LV - 02 WINDOW IOUVRE #1 COLOUR MONUMENT LV - 04 WINDOW IOUVRE #2 COLOUR MONUMENT



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Client UNIVERSITY OF NEW ENGLAND	Drawing Name EXTERNAL FINISHES			
Project Name NEW ROBB COLLEGE	- Scale Project No Date (@ A3 17116		Date Created	
	Drawing No DA-A-9601		Revision TP5	

INTERNAL COURTYARD FINISHES

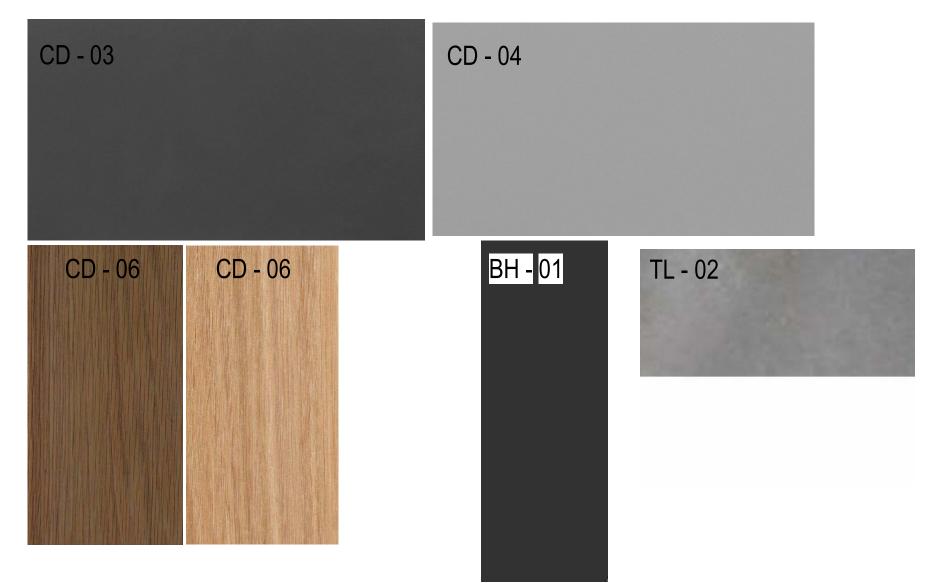


LEGEND

- CD 03 PREFINISHED FIBRE CEMENT PANELS: PROFILED CEMINTEL BASE COLOUR BLACKISH
- CD 04 PREFINISHED FIBRE CEMENT PANELS: NON PROFILED CEMINTEL BASE COLOUR GREYISH
- CD 06 BATTEN SCREEN COLOUR BLACKBUTT + MERSEY OAK
- BH 01 CUSTOM BALUSTRADES COLOUR TO MATCH IRONSTONE
- TL 02 EXPOXY FINISH CONCRETE FLOOR COLOUR TO MATCH GRANITE UNIT PAVING



Client UNIVERSITY OF NEW ENGLAND	Drawing Name INTERNAL FINISHES		7:57 PM	
Project Name NEW ROBB COLLEGE	Scale Project No Date Created @ A3 17116	2019 4:0		
	Drawing No DA-A-9602		Revision TP4	4/8/20

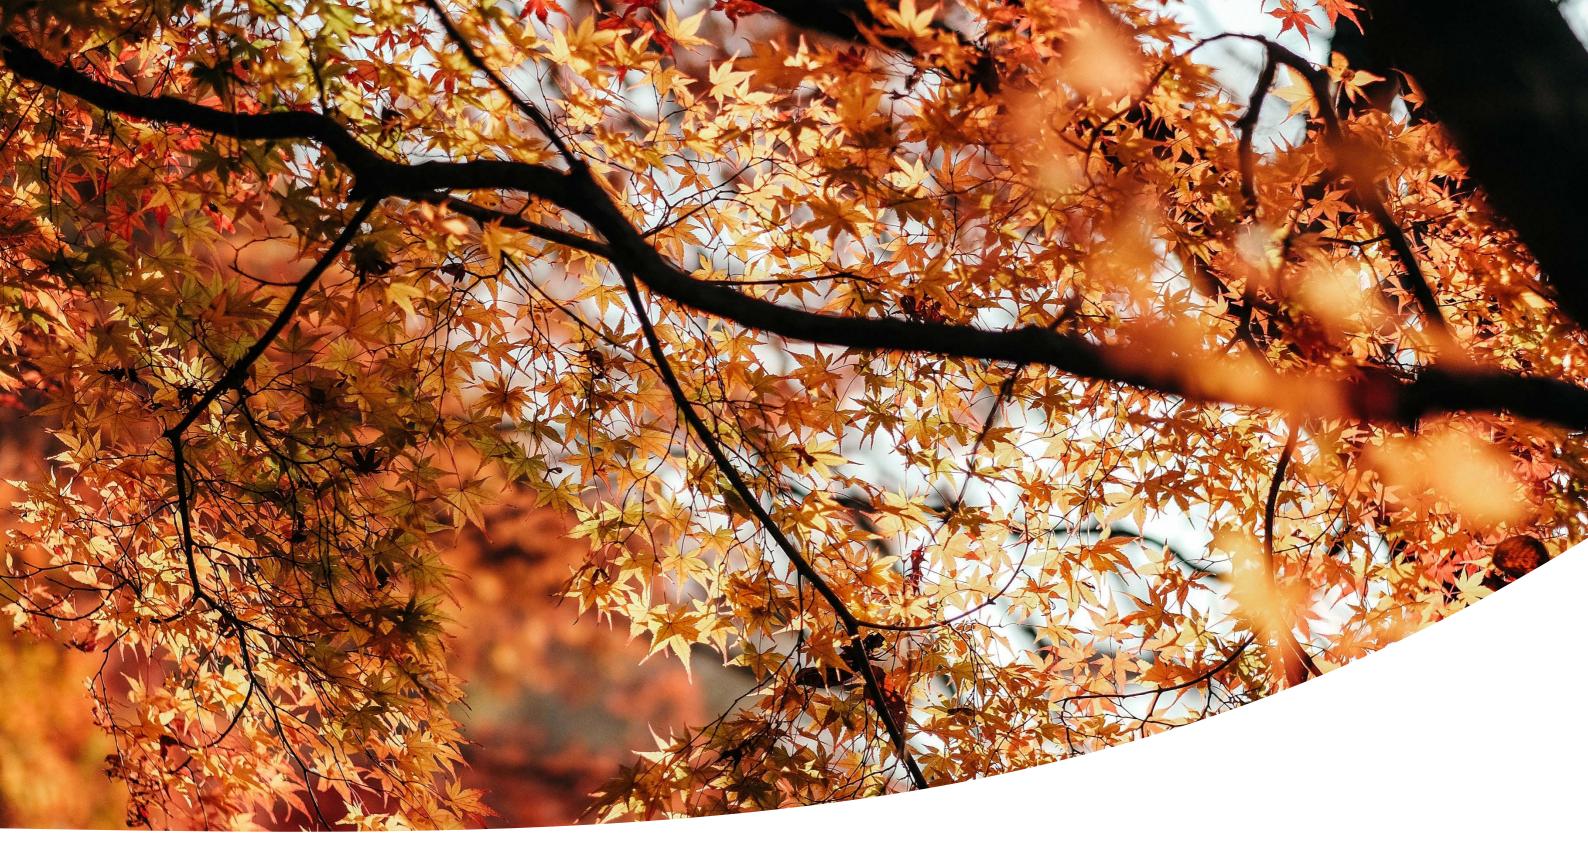

UNE ROBB COLLEGE LANDSCAPE DESIGN APPLICATION MARCH 2019



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1.0 SITE UNDERSTANDING

- CONTEXT REGIONAL 1.1
- 1.2 CONTEXT CAMPUS
- 1.3 ANALYSIS CLIMATE
- 1.4 ANALYSIS U N E
- ANALYSIS ROBB COLLEGE 1.5
- 1.6 ANALYISIS EXISTING SITE
- 1.7 ANALYISIS EXISTING TREES

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- 2.1 VISION
- 2.2 PRINCIPLES
- 2.3 STRATEGIES
- 2.4 THRESHOLD
- 2.5 MASTER PLAN
- 2.6 VILLAGE GREEN
- 2.7 SOUTH COURT
- 2.8 WEST COURT
- 2.9 NORTH COURT

- 3.1 MATERIAL PALETTE
- 3.2 PLANTING PALETTE




3.0 LANDSCAPE SYSTEMS

DATE March 2019 SCALE ISSUE E

SITE UNDERSTANDING

1.0


1.1 CONTEXT REGIONAL

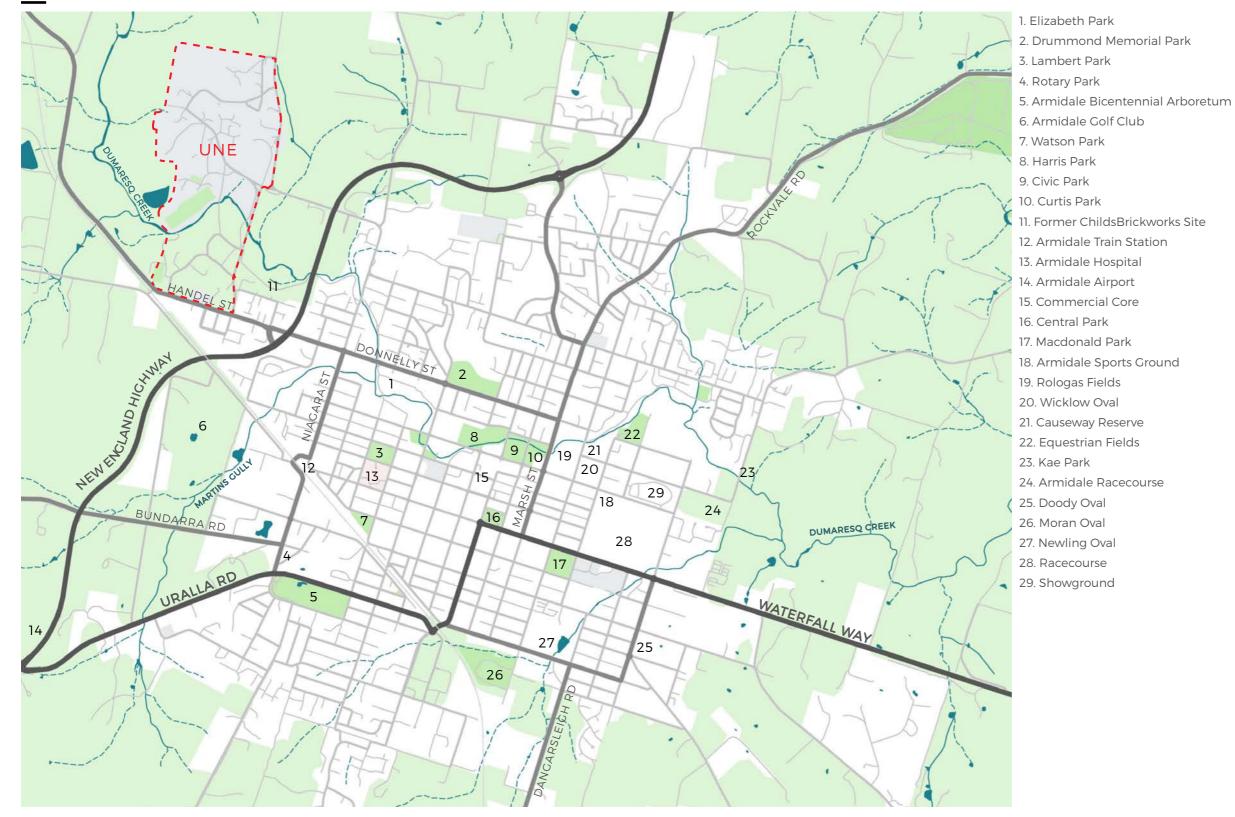



DATE March 2019 SCALE ISSUE E

1.2 CONTEXT CAMPUS

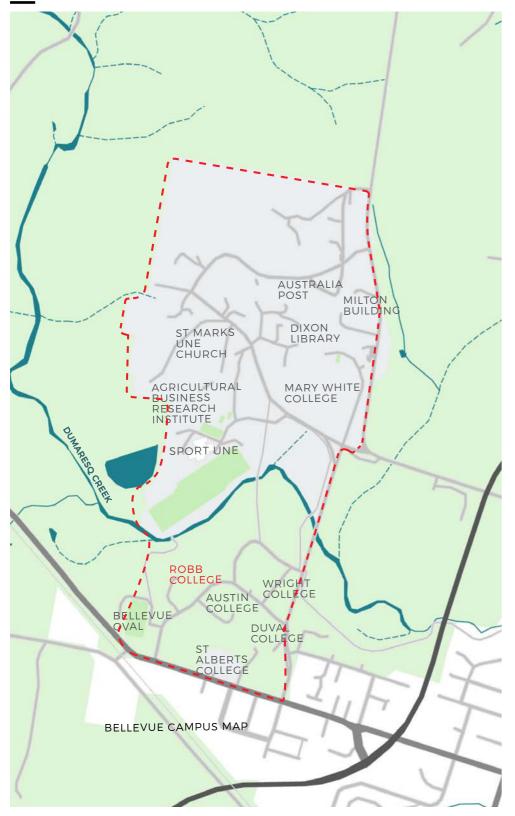




UNE CAMPUS MAP



DATE March 2019 SCALE ISSUE E

1.3 ANALYSIS CLIMATE

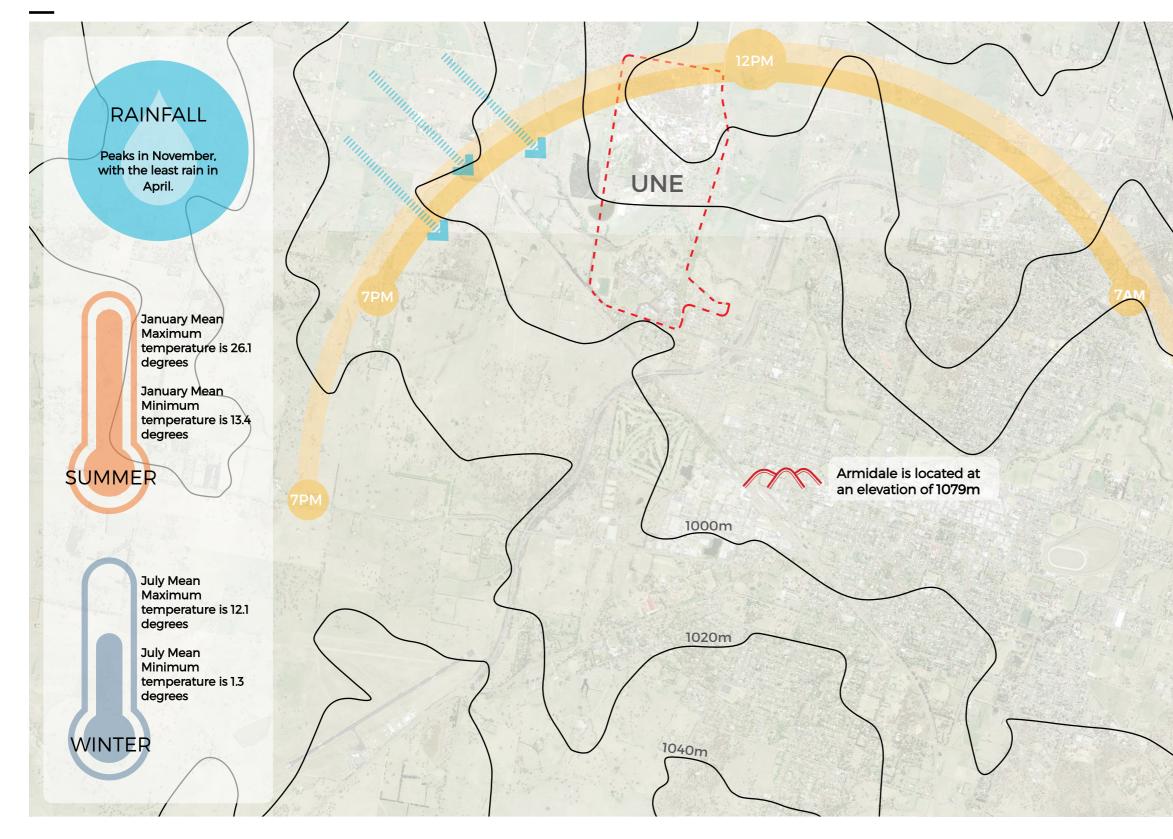

ARCADIA

UNE ROBB COLLEGE ARMIDALE

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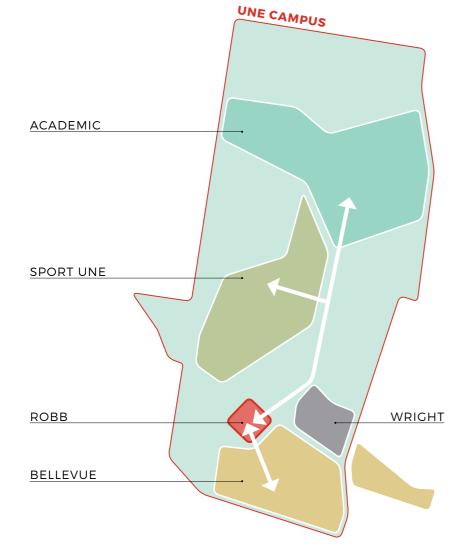


1.4 ANALYSIS UNE


The New England University College (NEUC) was formed in 1938 as a college of the University of Sydney, it was recognised as 'The College of the North"

The University became fully independent as the University of New England in 1954. Pioneering in teaching to external students by correspondence, UNE became Australia's most experienced provider of distance and now Online Education to its students.





FORMATIVE RESPECTFUL INCLUSIVE

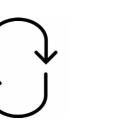



David Drummond founded the Armidale Teachers College, which layed the foundation for a future University

The Univeristy of New England became fully





1954

1929







'Booloominbah' was built and occupied until 1930. It is now the centre of The University of New England



University College (NEUC) was formed as a college of the University of Sydney





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UNE ROBB COLLEGE ARMIDALE





FLEXIBLE



INNOVATIVE



Prof Bruce Thom was the first Vice Chancellor of the





1993 <u>1989</u>

university consisting of: - Campus at Armidale - Campus at Lismore - Orange Agricultural College - UNE Coffs Harbour





UNE has one of the most extensive residential college systems in Australia.

Billard Leece Partnership

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1.5 ANALYSIS ROBB COLLEGE

Robb college first opened in 1960. It was originally known as the 'Third College' and was one of the first modernist colleges built outside of Sydney. It is designed in keeping with the Oxbridge courtyard planning style.

Robb College is named after the first Registrar of the UNE, Mr William Menzies Robb. It was originally established as a men's college, however Robb has been co-ed since 1977.

The Robb College motto is 'Fellowship in Learning'



SOCIAL CULTURE SPORT

EXISTING SITE MATERIALITY



BASALT

STAINED TALLOWWOOD

CONCRETE BARREL-VAULTS



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COMMUNITY




SUPPORT

EXPOSED STEEL FRAMES

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1.6 ANALYSIS EXISTING SITE CONDITIONS



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INTERNAL PATH NETWORK

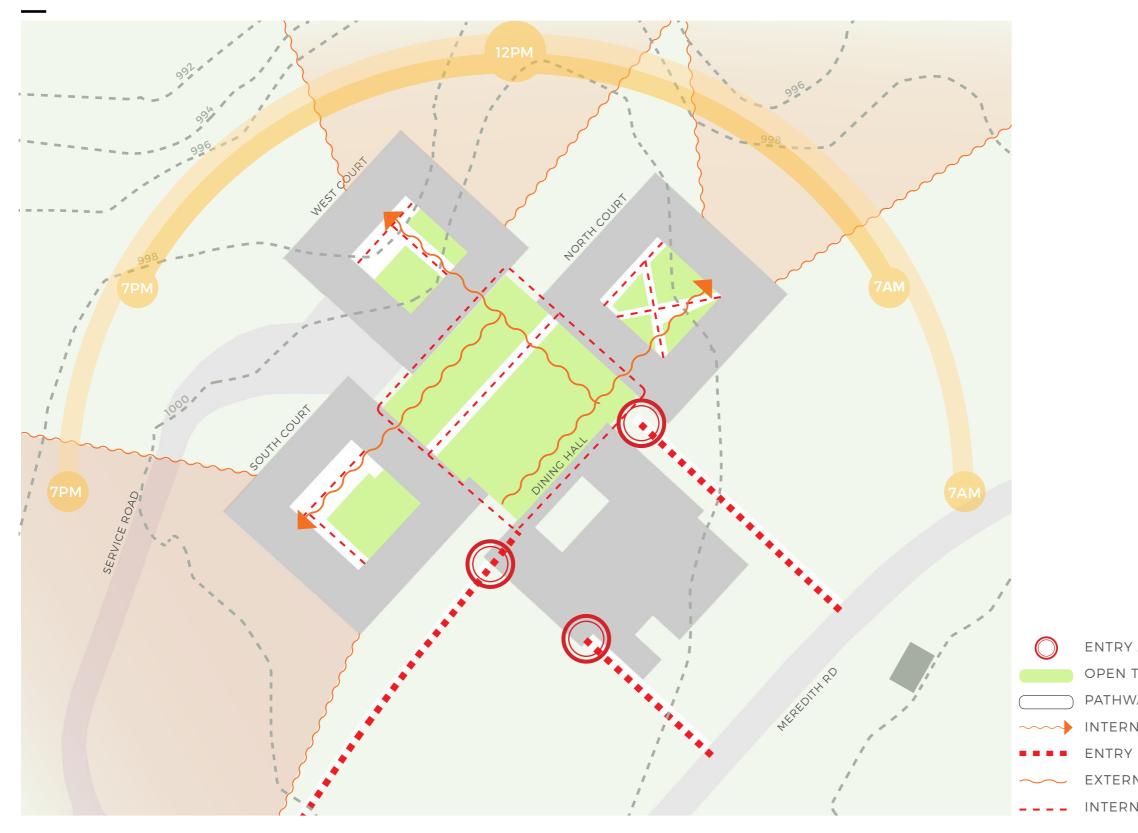EXTERNAL VIEW CORRIDORS

ENTRY PATHS INTO SITE

INTERNAL VIEW CORRIDORS

PATHWAYS AND HARDSCAPE

OPEN TURF AREAS

ENTRY AND EXIT POINTS

1.7 ANALYSIS EXISTING TREES



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UNE ROBB COLLEGE ARMIDALE

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Techincal Note:


State Environmental Planting Policy No 44 Koala Habitat Protection corridor acknowledged

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2.0

MASTER PLAN



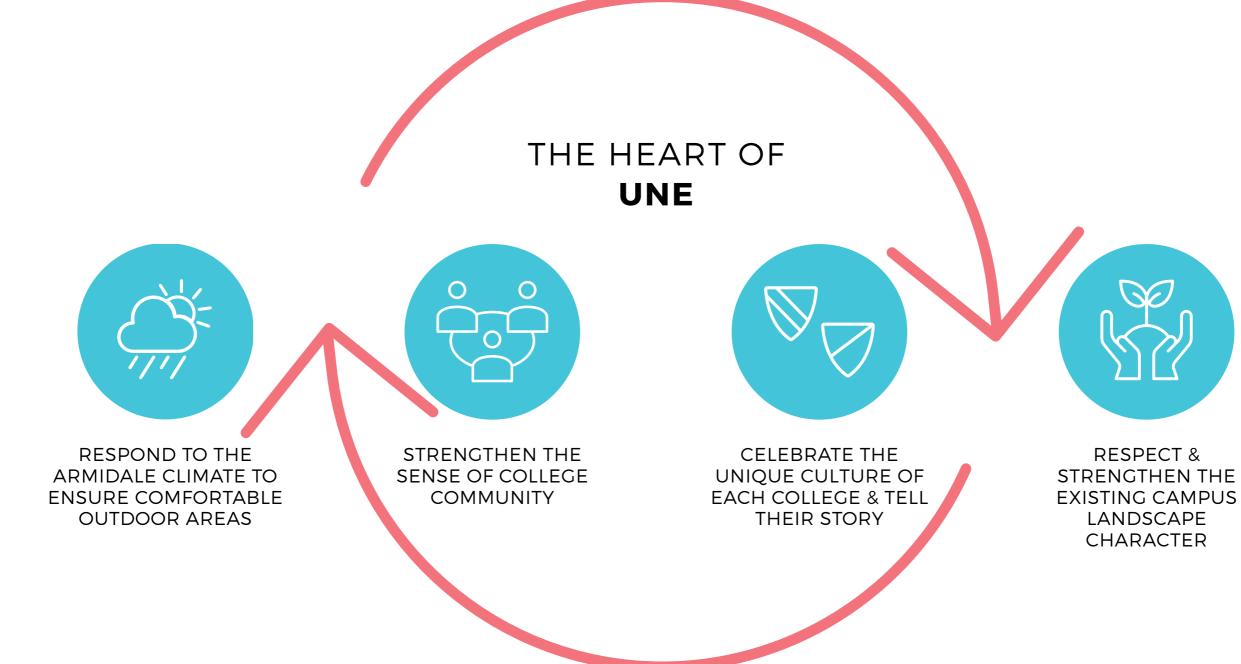

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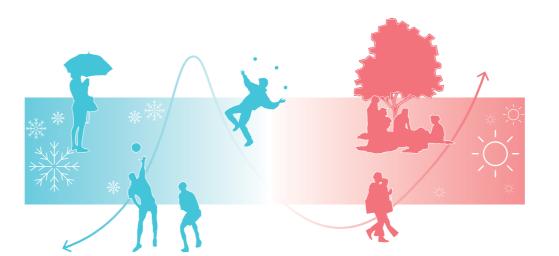
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2.2 PHILOSOPHY PRINCIPLES





CELEBRATE THE UNIQUE CULTURE OF EACH COLLEGE & TELL THEIR STORY





- PROVIDING SHELTER & WARM SPACES
- CONSIDER DRYING ROOMS FOR WINTER
- PLEASENT JOURNIES TO CLASS & BACK
- EVERGREEN VS DECIDUOUS TREES
- COMFORTABLE GATHERING SPACES
- THE USE OF WATER IN THE LANDSCAPE
- PROVIDE OUTDOOR SPACES WITH SHADE
- CONSIDER WATER BUBBLER'S

UNE ROBB COLLEGE ARMIDALE




RESPECT & STRENGTHEN THE EXISTING CAMPUS LANDSCAPE CHARACTER

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13



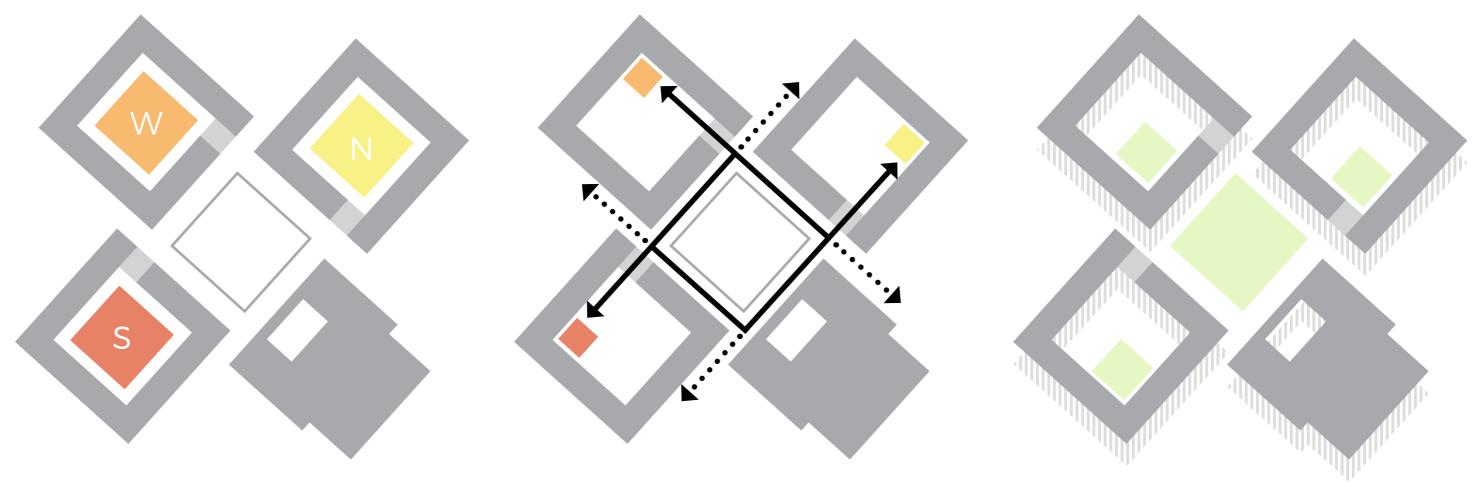

SEASONAL DNA

AXIS + VISTA

ARCADIA


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LIGHT + SHADE







PROGRAM

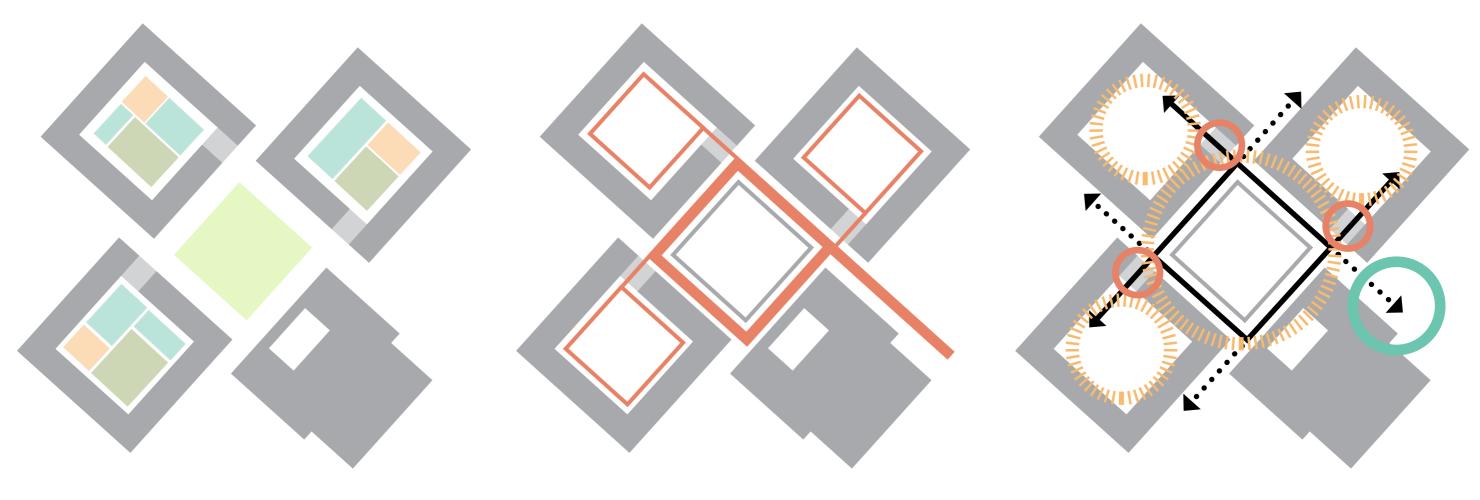PAVILION (EATING/DINING) AMENITY (SEATING/ACTIVE/STUDY) BLOCK GREEN (ACTIVE/OPEN SPACE) VILLAGE GREEN (MEETING PLACE)

HEIRACHY



UNE ROBB COLLEGE ARMIDALE

GATEWAY THRESHOLD


O COLLEGE THRESHOLD

O BLOCK THRESHOLD

ARRIVAL EXPERIENCE

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2.4 DESIGN THRESHOLD MOMENTS

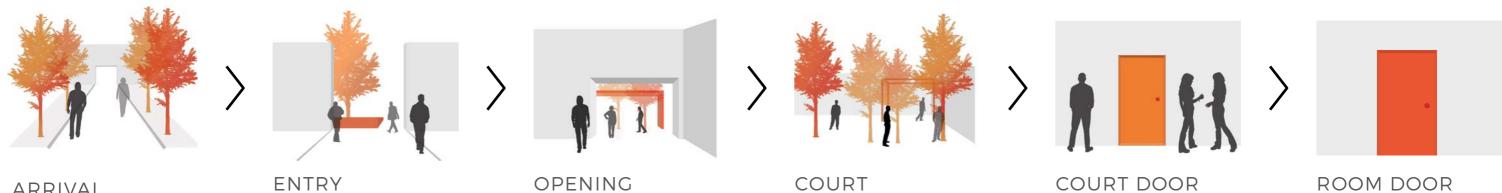

ARRIVAL

ENTRY

OPENING

COURT



UNE ROBB COLLEGE ARMIDALE


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ROOM DOOR

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16


2.4 DESIGN LANDSCAPE THRESHOLD MOMENTS



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2.6 DESIGN VILLAGE GREEN

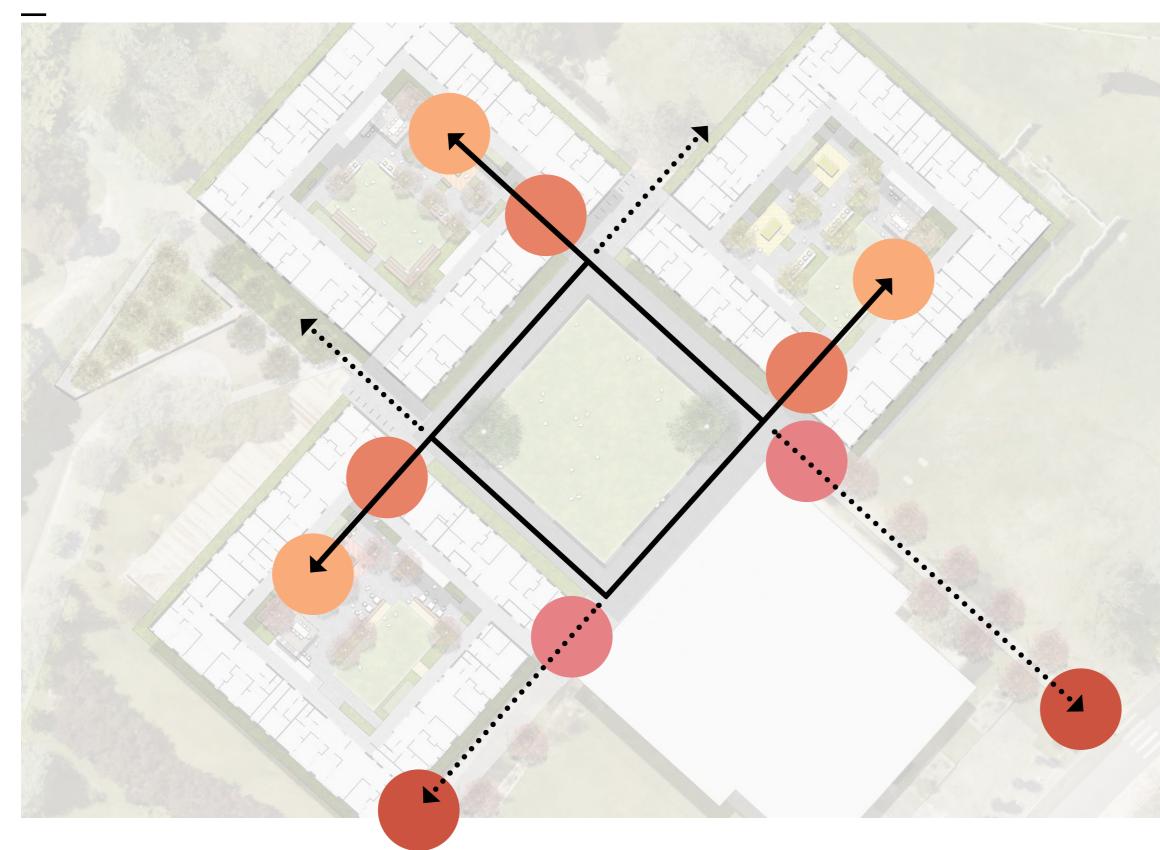

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SCALE 1:250 @ A3

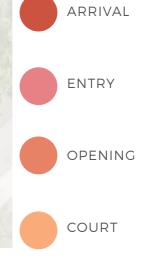

2.7 DESIGN SOUTH COURT




ARCADIA

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2.7 DESIGN SOUTH COURT SECTIONS



SECTION AA - 1:100 @ A3

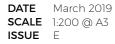

SECTION BB - 1:100 @ A3



UNE ROBB COLLEGE ARMIDALE



KEY PLAN

SCALE 1:100 @ A3



2.8 DESIGN WEST COURT



ARCADIA

UNE ROBB COLLEGE ARMIDALE



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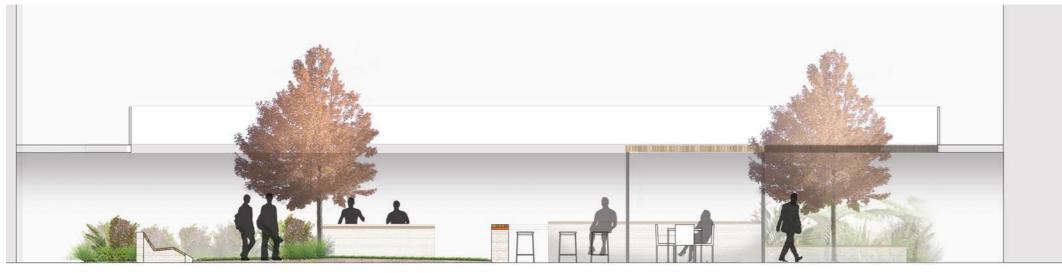


8. WORK BENCH FOR SMALL GROUPS

DATE March 2019
 SCALE
 1:250 @ A3

 ISSUE
 E

2.8 DESIGN WEST COURT SECTIONS




SECTION CC - 1:100 @ A3



SECTION BB - 1:100 @ A3



UNE ROBB COLLEGE ARMIDALE

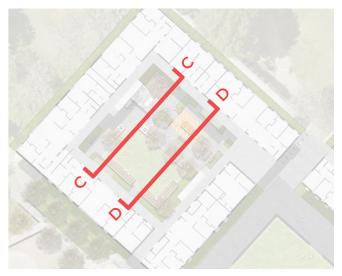

KEY PLAN

SCALE 1:100 @ A3



2.9 DESIGN NORTH COURT



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7. WORK BENCH FOR SMALL GROUPS

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2.9 DESIGN NORTH COURT SECTIONS




SECTION EE - 1:100 @ A3



SECTION FF - 1:100 @ A3



UNE ROBB COLLEGE ARMIDALE

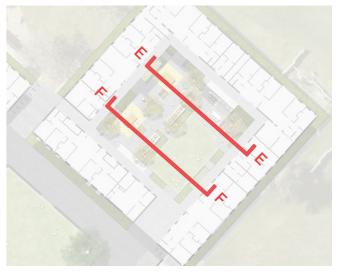

KEY PLAN

SCALE 1:100 @ A3



LANDSCAPE SYSTEMS

3.0

3.1 MATERIAL PALETTE







WALLS AND EDGES


Techincal Note - State Environmental Planting Policy No 44 Koala Habitat Protection

In response to the State Environmental Planting Policy No 44 Koala Habitat Protection the Robb College project beofre the project was proposed and therefore no existing koala habitat has being affected. has proposed tree species that are local sources of food for the Koala.

3.2 PLANTING PALETTE We acknowledge that habitat loss and fragmentation of tree canopy due to urban expansion is a key treat to koala habitat and food supply, including clearing for agriculture, bushfire, road kills, urban fencing, disease and domestic dogs.

The University of New England Robb College Project does not increase its original foot print

The project has proposed local koala feed trees of Mountain White Gum Eucalyptus dalrmpleana and Yellow Box Eucalyptus mellidora. We have located them to the northwest (See Section 2.5 MASterplan) of the project where the best the most likely location is for Koala habitat would occur within the project bundaries. This will then encourage the linking of koala habitat and provide protection and food for the species.

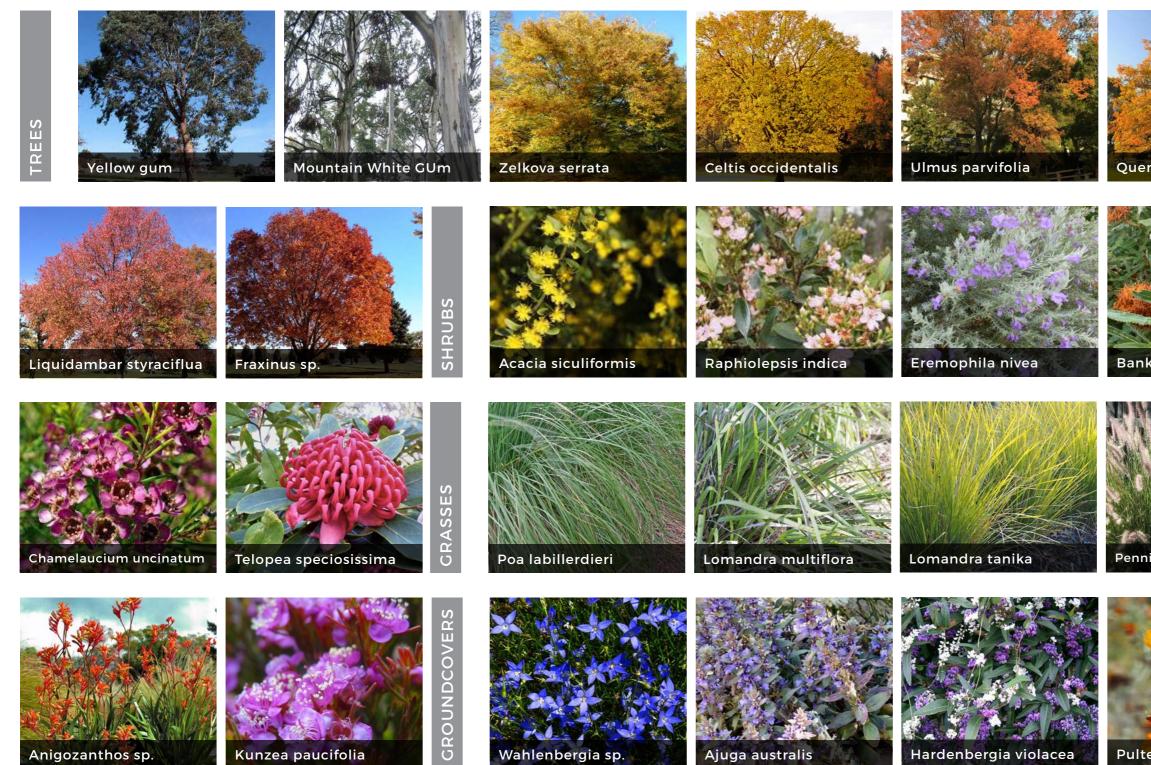



















DATE March 2019


28

PLANTING SCHEDULE

8-33	5 ROBB COLLEGE PLAN	NI SCHEDULE			
CODE	BOTANIC NAME	COMMON NAME	(h x w) (m)	PROPOSED POT SIZE	QUANTITY
	TREES & PALMS				
Bp	Betula pendula	Silver Birch	10 x 5	200L	7
Em	Eucalyptus melliodora	Yellow Box	15 x 10	200L	7
Ed	Eucalyptus dalrympleana	Mountain White Gum	15 x 10	200L	6
Ls	Liquidambar styraciflua	Sweet Gum	30 x 15	200L	28
Pch	Pistacia chinensis	Chinese Pistachio	15 x 10	200L	7
Qr	Quercus robur	Common Oak	15 x 10	200L	9
	SHRUBS & ACCENTS				
Acl	Acacia cognata 'limelight'	Prostrate wattle 'limelight'	0.5 x 0.5	300mm	120
As	Adenanthos sericeus	Woolly Bush	3 x 1.5	300mm	28
Bm	Banksia menziesii	Banksia	1.5 x 1.5	300mm	4
Cu	Chamelaucium uncinatum	Wax flower	l x 2	300mm	3
Gn	Gevillea 'Noelli'	Noell Grevillea	1.5x1	300mm	61
Ri	Raphiolepsis indica	Hawthorn	1.5 x 1.5	300mm	10
Ts	Telopea speciosissima	Waratah	2.5 x 2.5	300mm	9
	GRASSES & RUSHES				
Agz	Anigozanthos spp.	Kangaroo Paw	1.5 x 0.5	150mm	420
Ic	Imperata cylindrica	Blady Grass	1 x 1.5	150mm	322
Kp	Kunzea paucifolia	Pretty Pink Myrtle	lx1.5	150mm	56
Lm	Lomandra multiflora	Many-headed Mat rush	l x l	150mm	322
Lg	Lomandra 'grey leaf'	Grey Leaf Lomandra	0.6x0.6	150mm	322
Lt	Lomandra 'tanika'	Lomandra Tanika	0.6x0.6	150mm	247
Ρα	Pennisetum alopecurioides	Swamp foxtail	1.5x1.5	150mm	322
Pl	Poa labillerdieri	Tussock Grass	lxl	150mm	31
Ps	Poa sieberiana	Snow Grass	1 x 1	150mm	322
Τα	Themeda australis	Kangaroo Grass	l x l	150mm	322
	GROUNDCOVERS & CLIMBERS				
Aa	Ajuga australis	Austral Bugle	0.5 x spreading	150mm	144
Hv	Hardenbergia violacea	Purple Pea	0.6 x spreading	150mm	198
Pm	Pultenaea microphylla	Small Leaved Bush Pea	0.8 x spreading	150mm	198
Wa	Wahlenbergia sp.	Blue Bells	0.5 x spreading	150mm	123





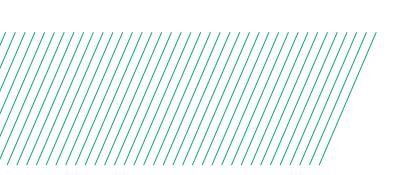

KEY PLAN

		\	
401	Total Control		02 1
403	404		
	40	6	


UNE ROBB COLLEGE ARMIDALE **DEVELOPMENT APPLICATION**



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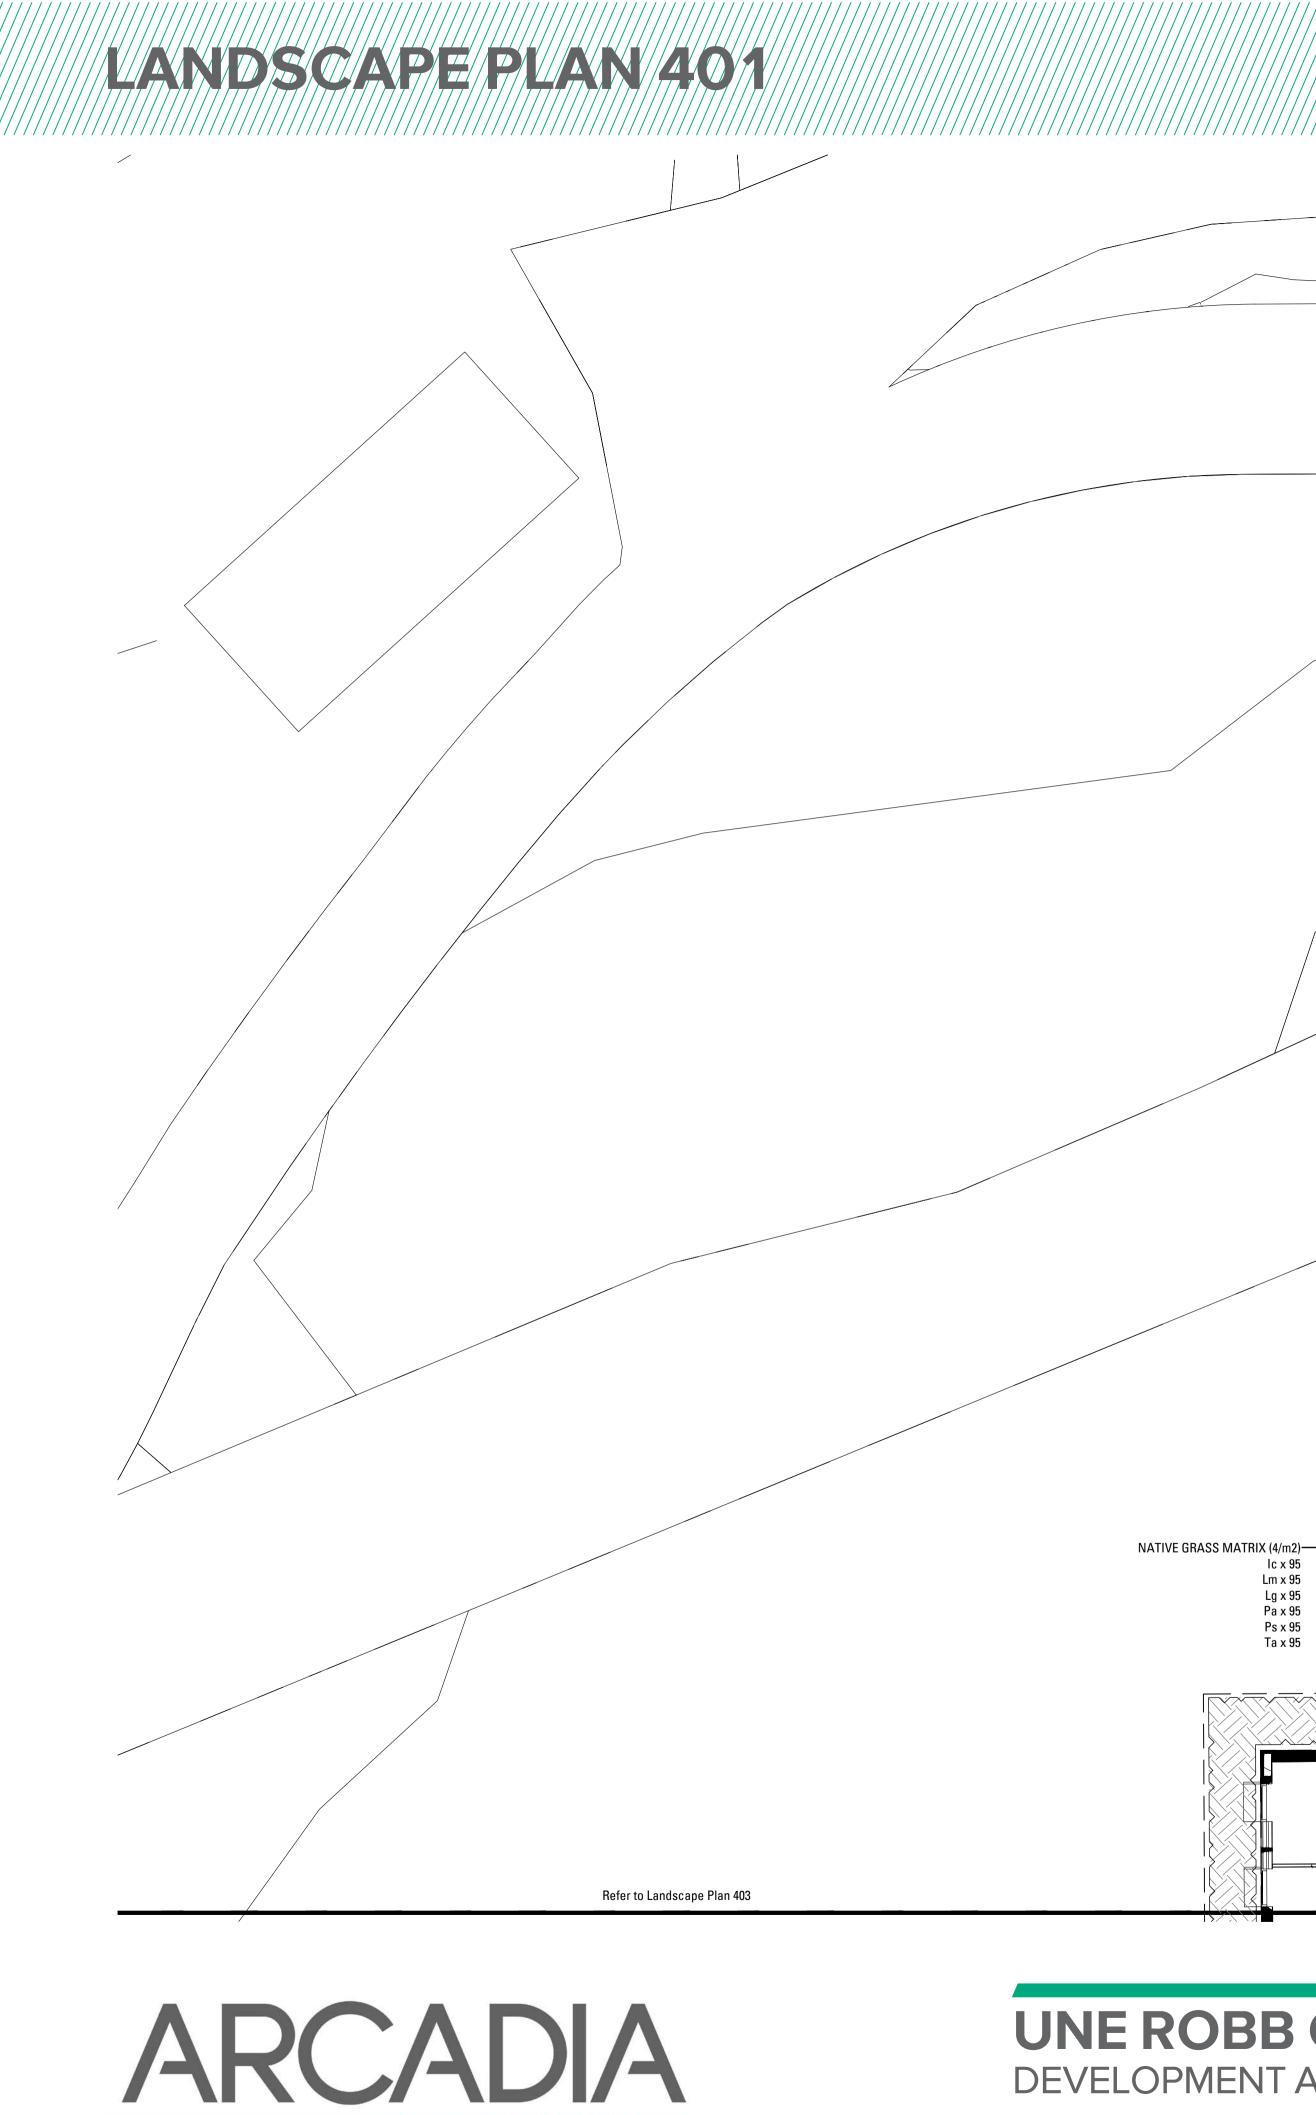




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lc x 95 Lm x 95 Lg x 95 Pa x 95 Ps x 95

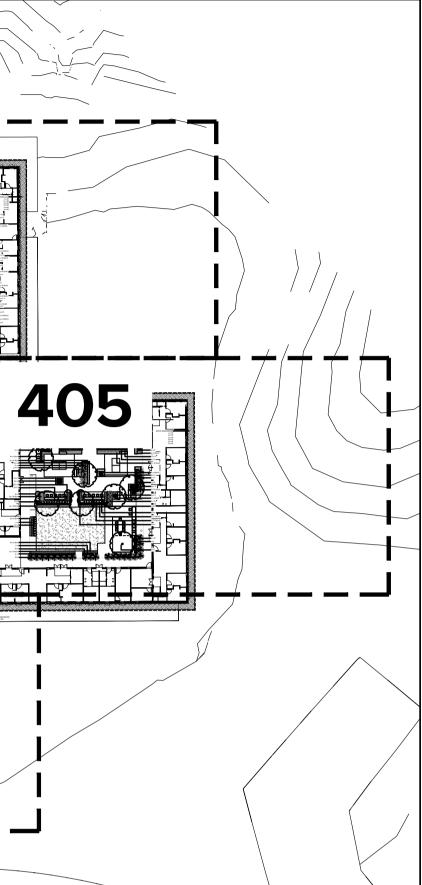Ta x 95


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Refer to Landscape Plan 404



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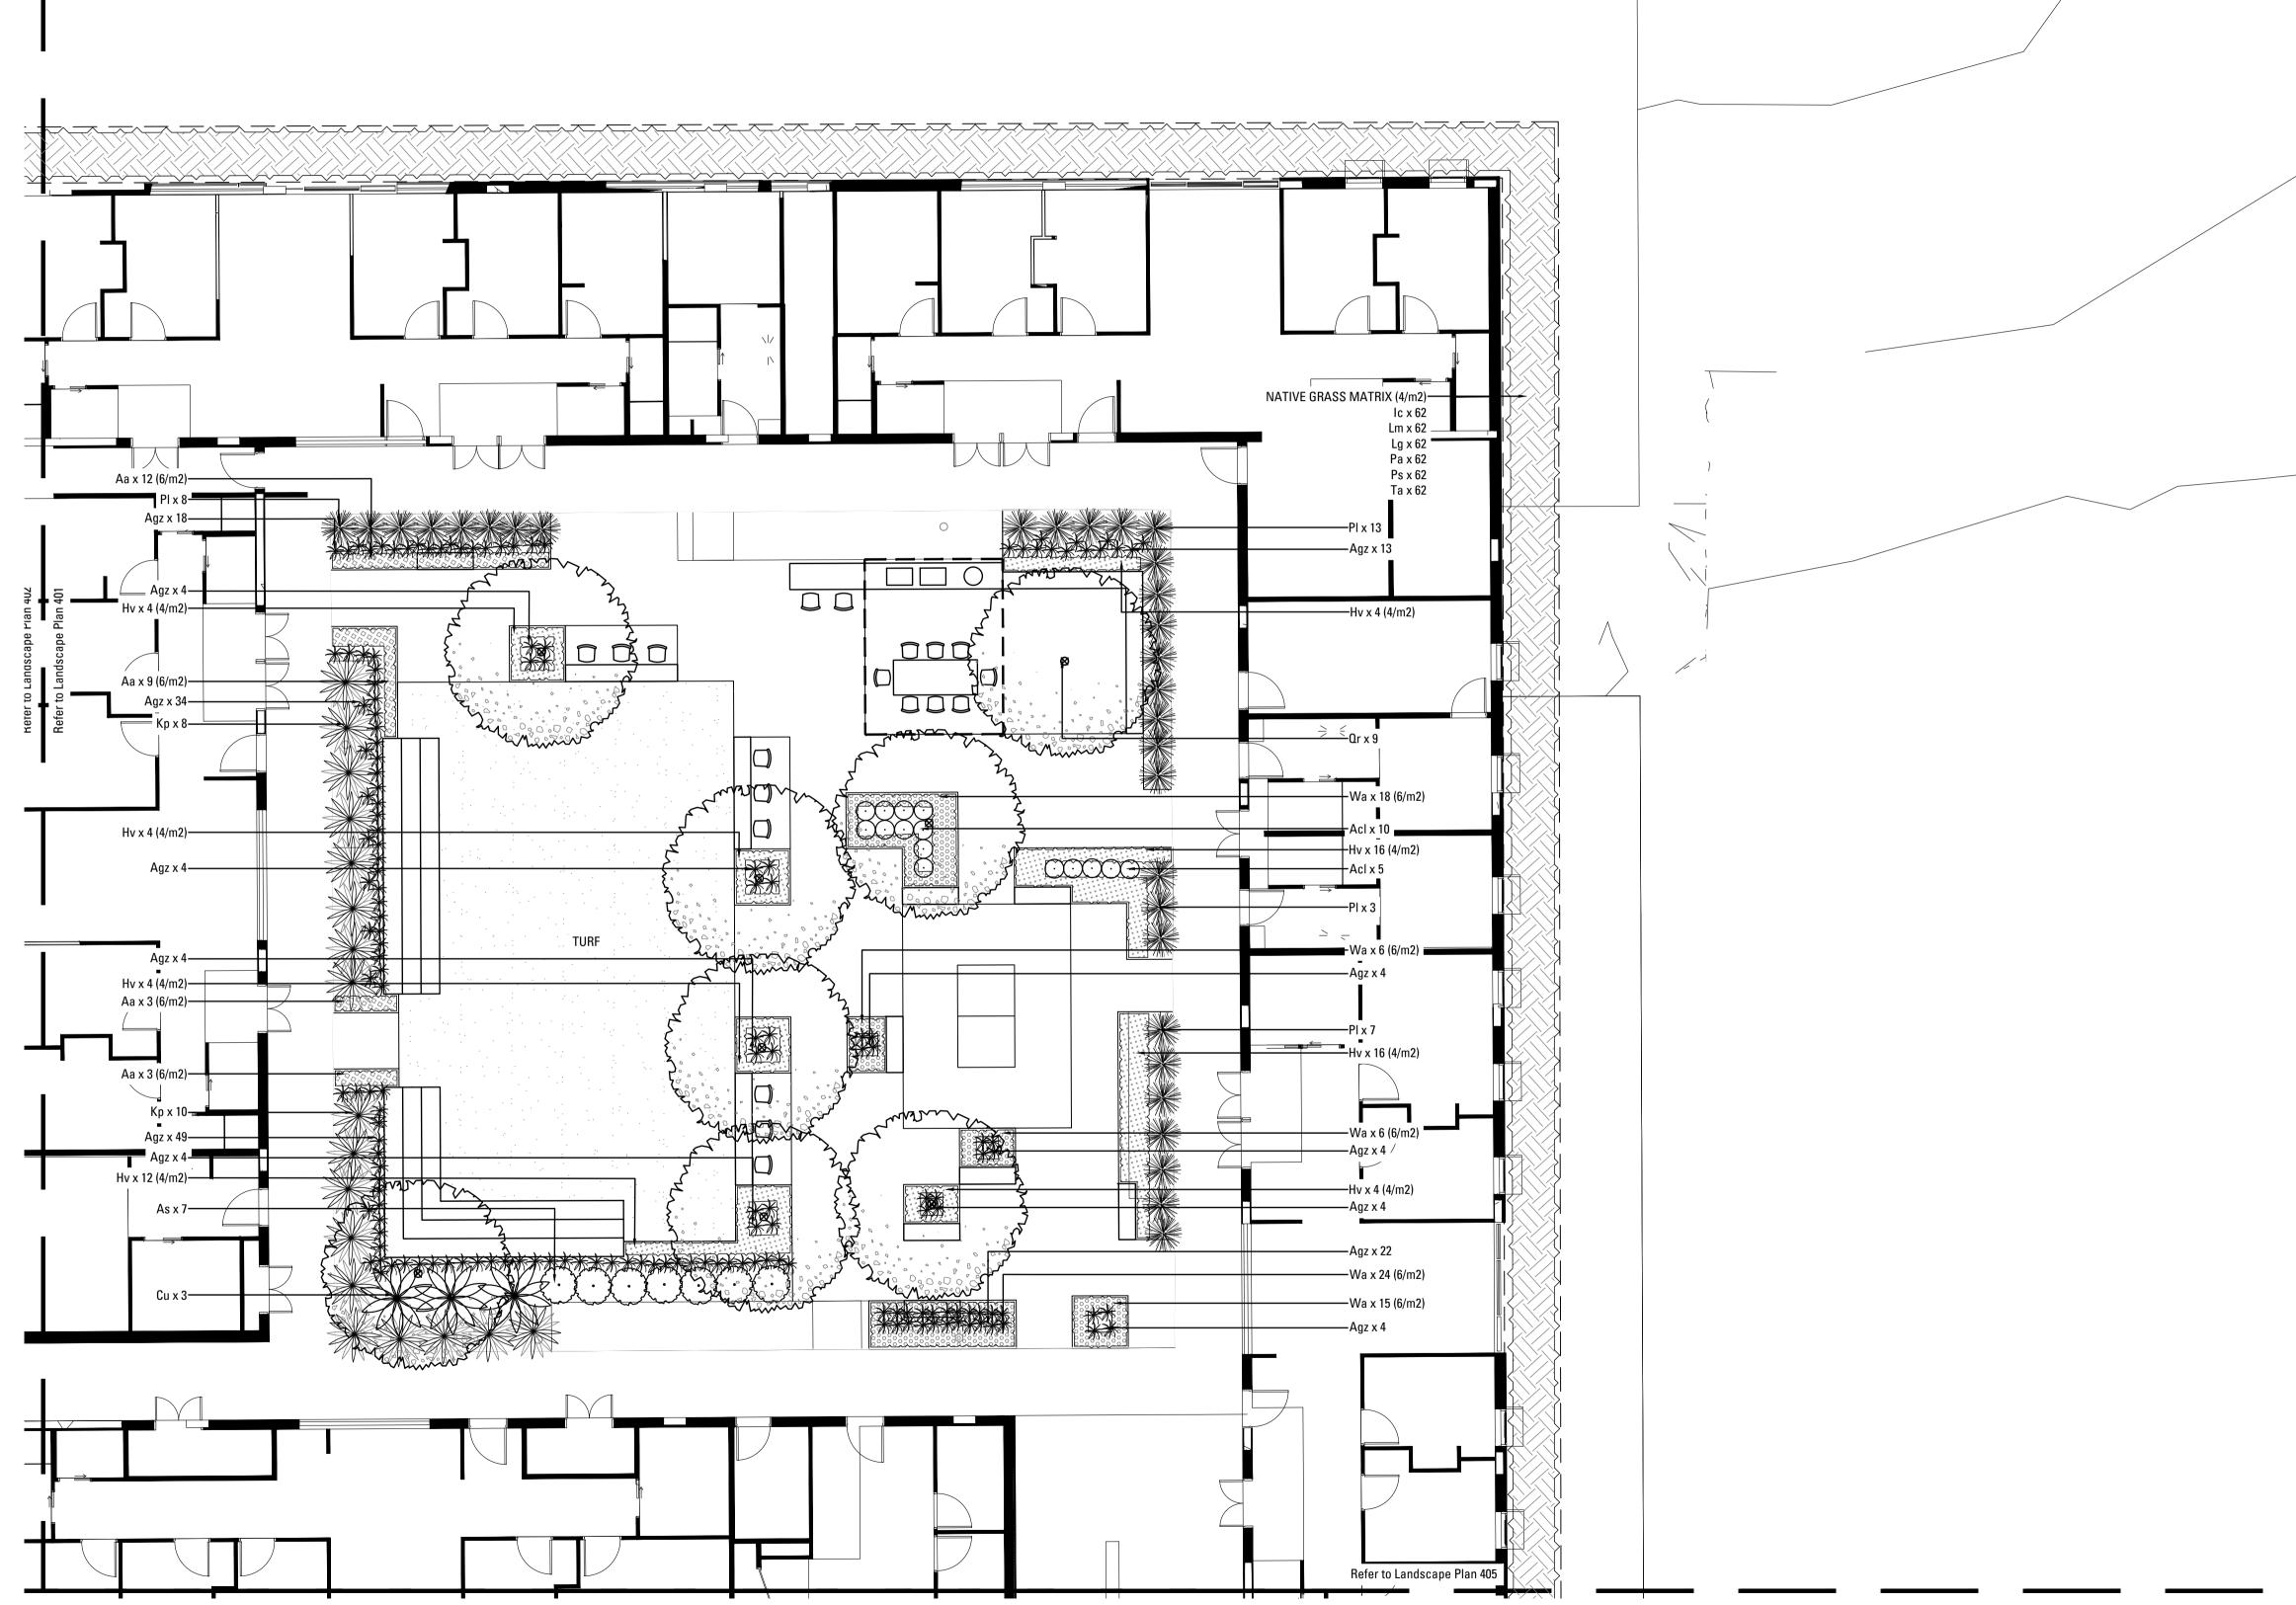
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LANDSCAPE PLAN 402



ARCADIA LANDSCAPE ARCHITECTURE

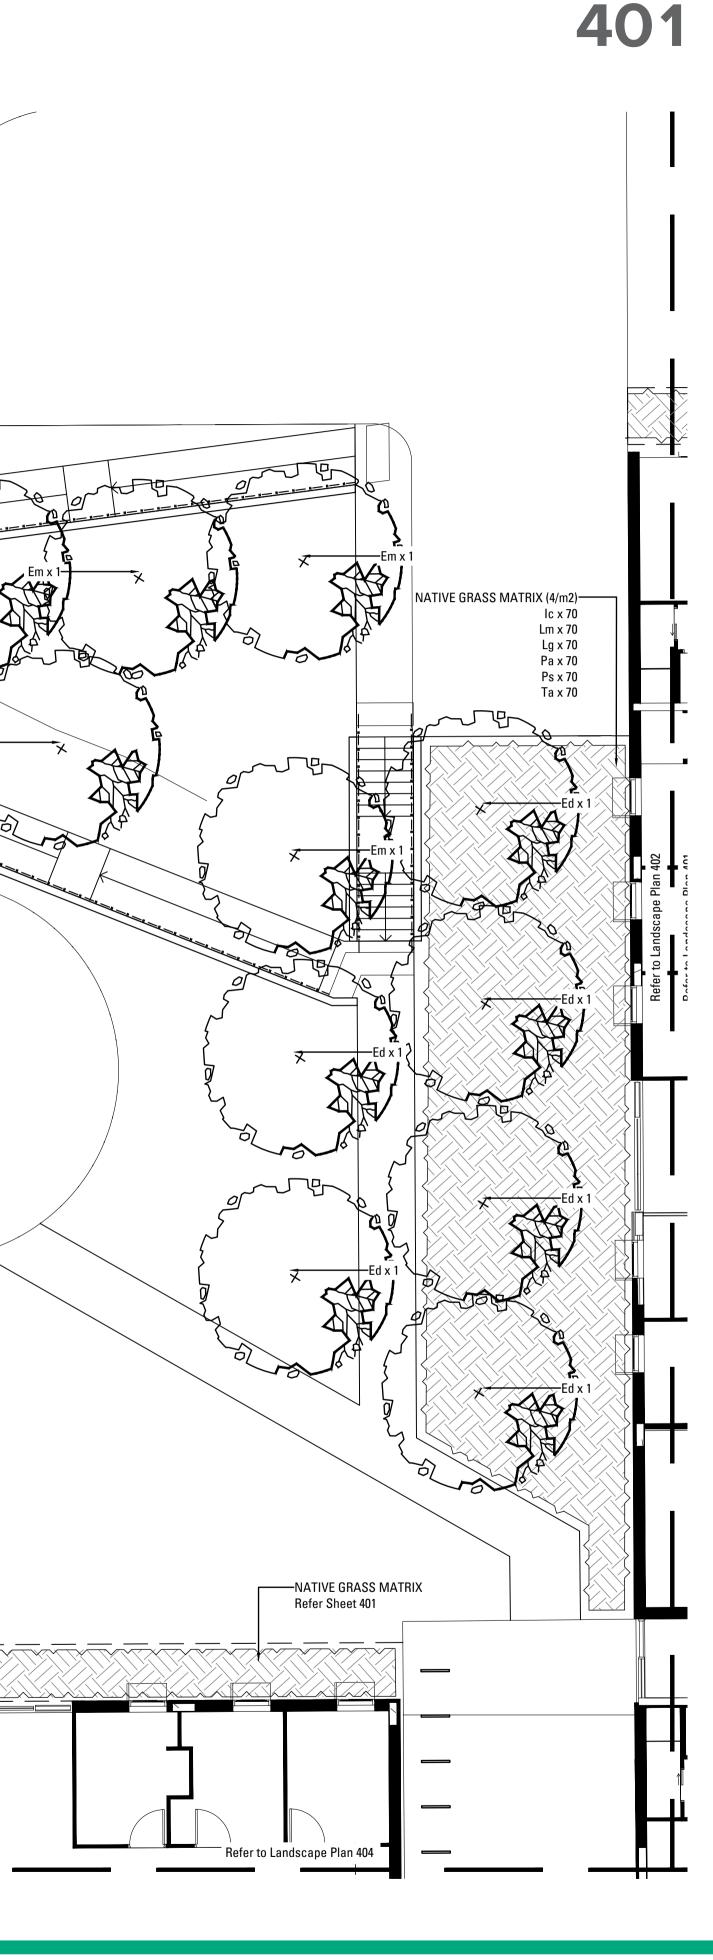

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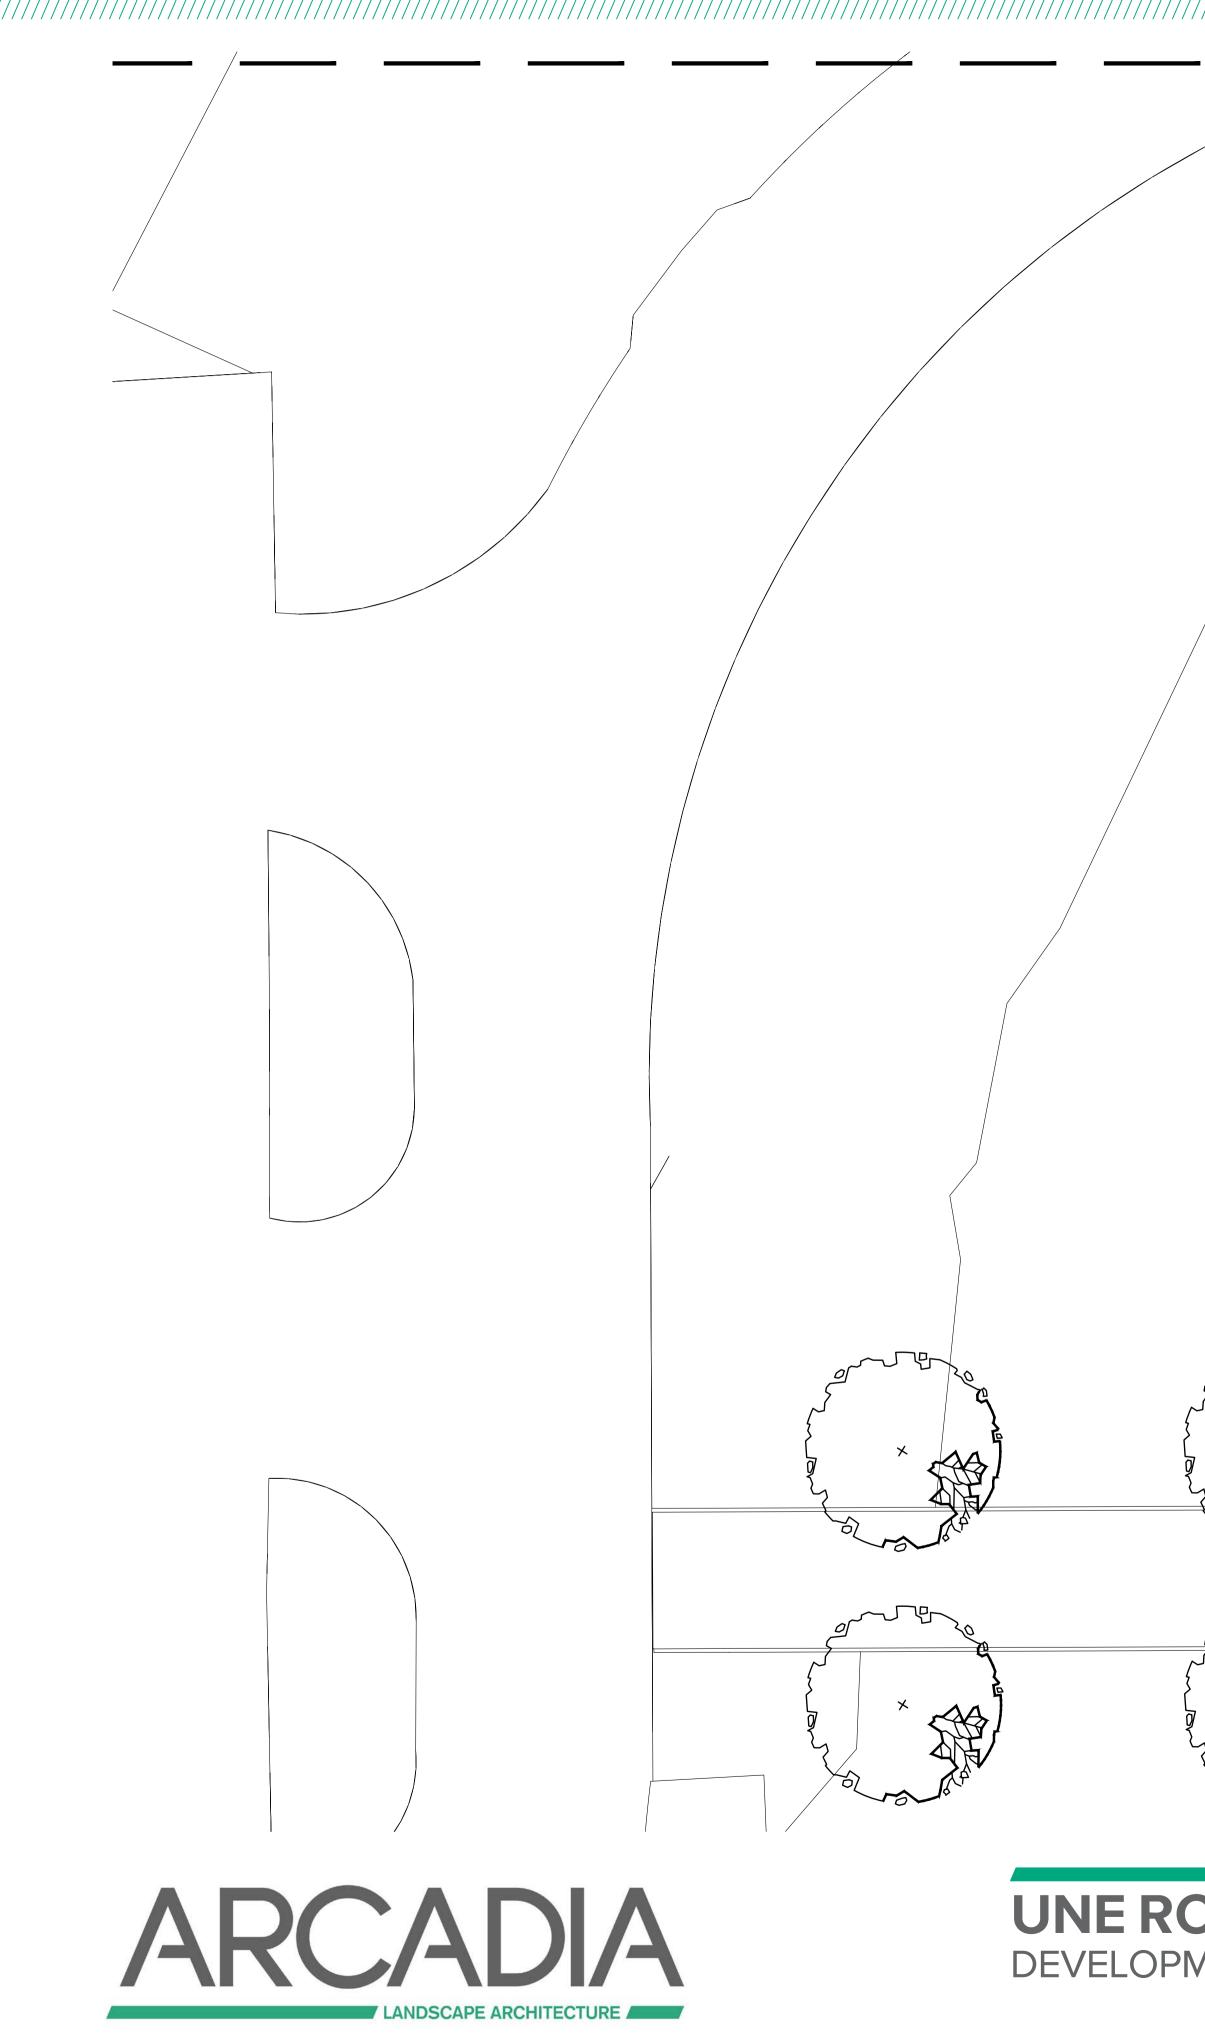


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LANDSCAPE PLAN 403



UNE ROBB COLLEGE ARMIDALE **DEVELOPMENT APPLICATION**

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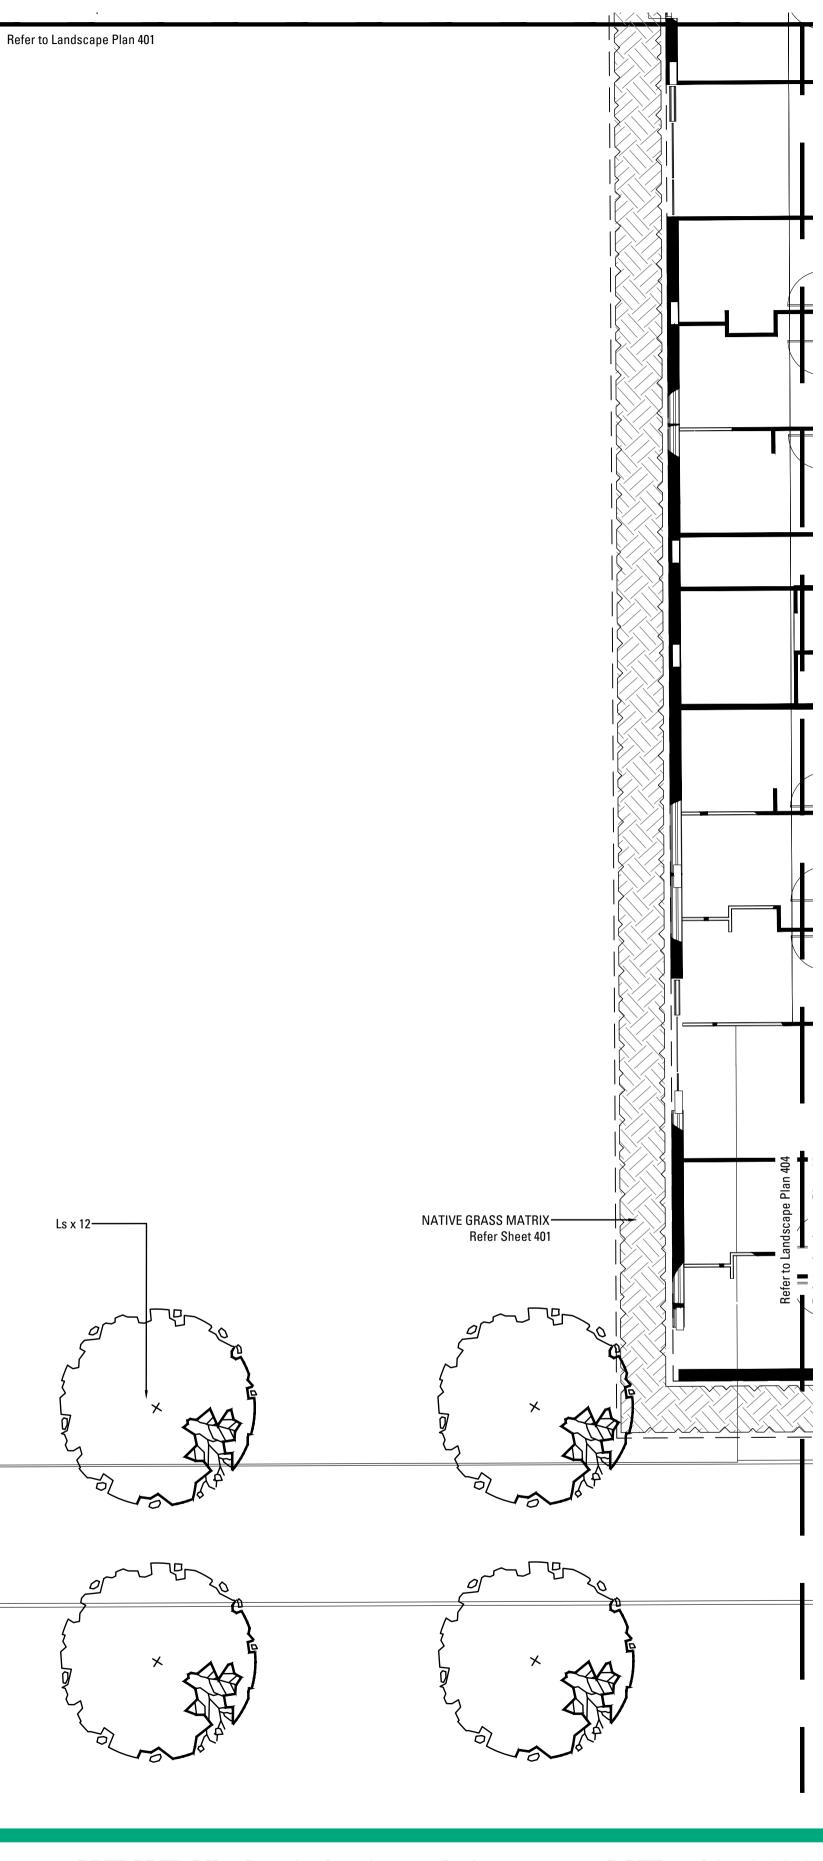
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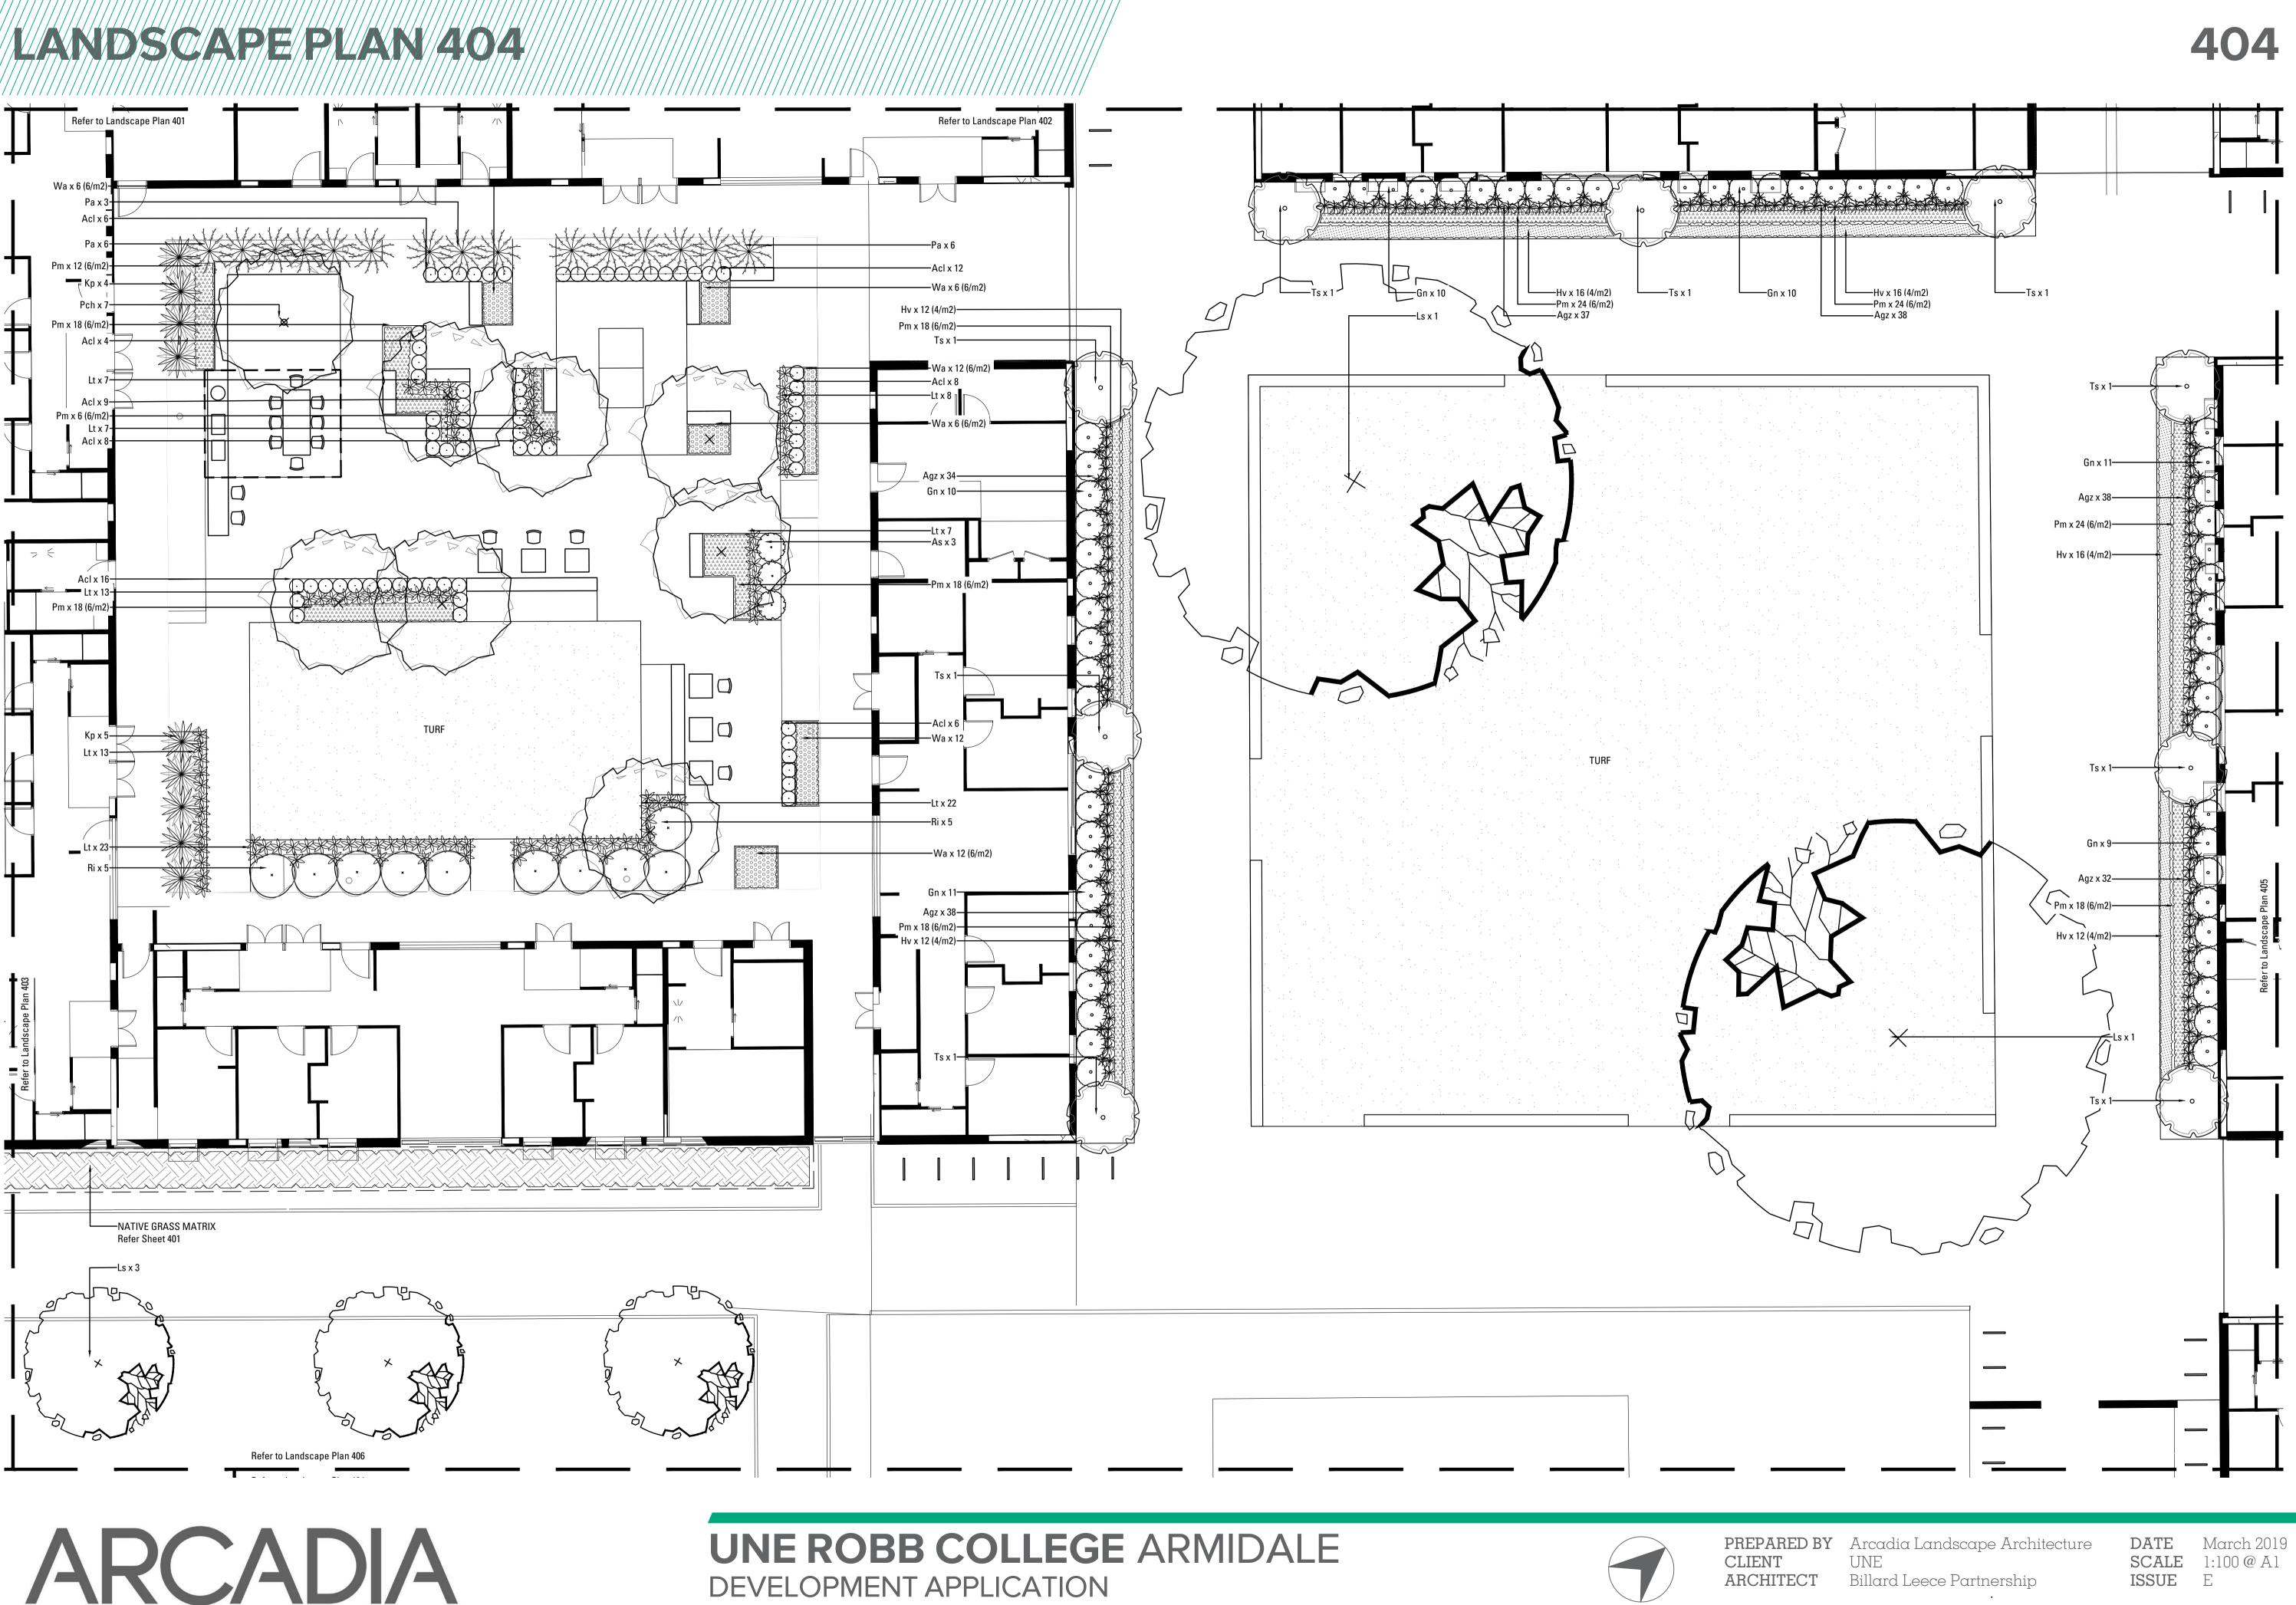


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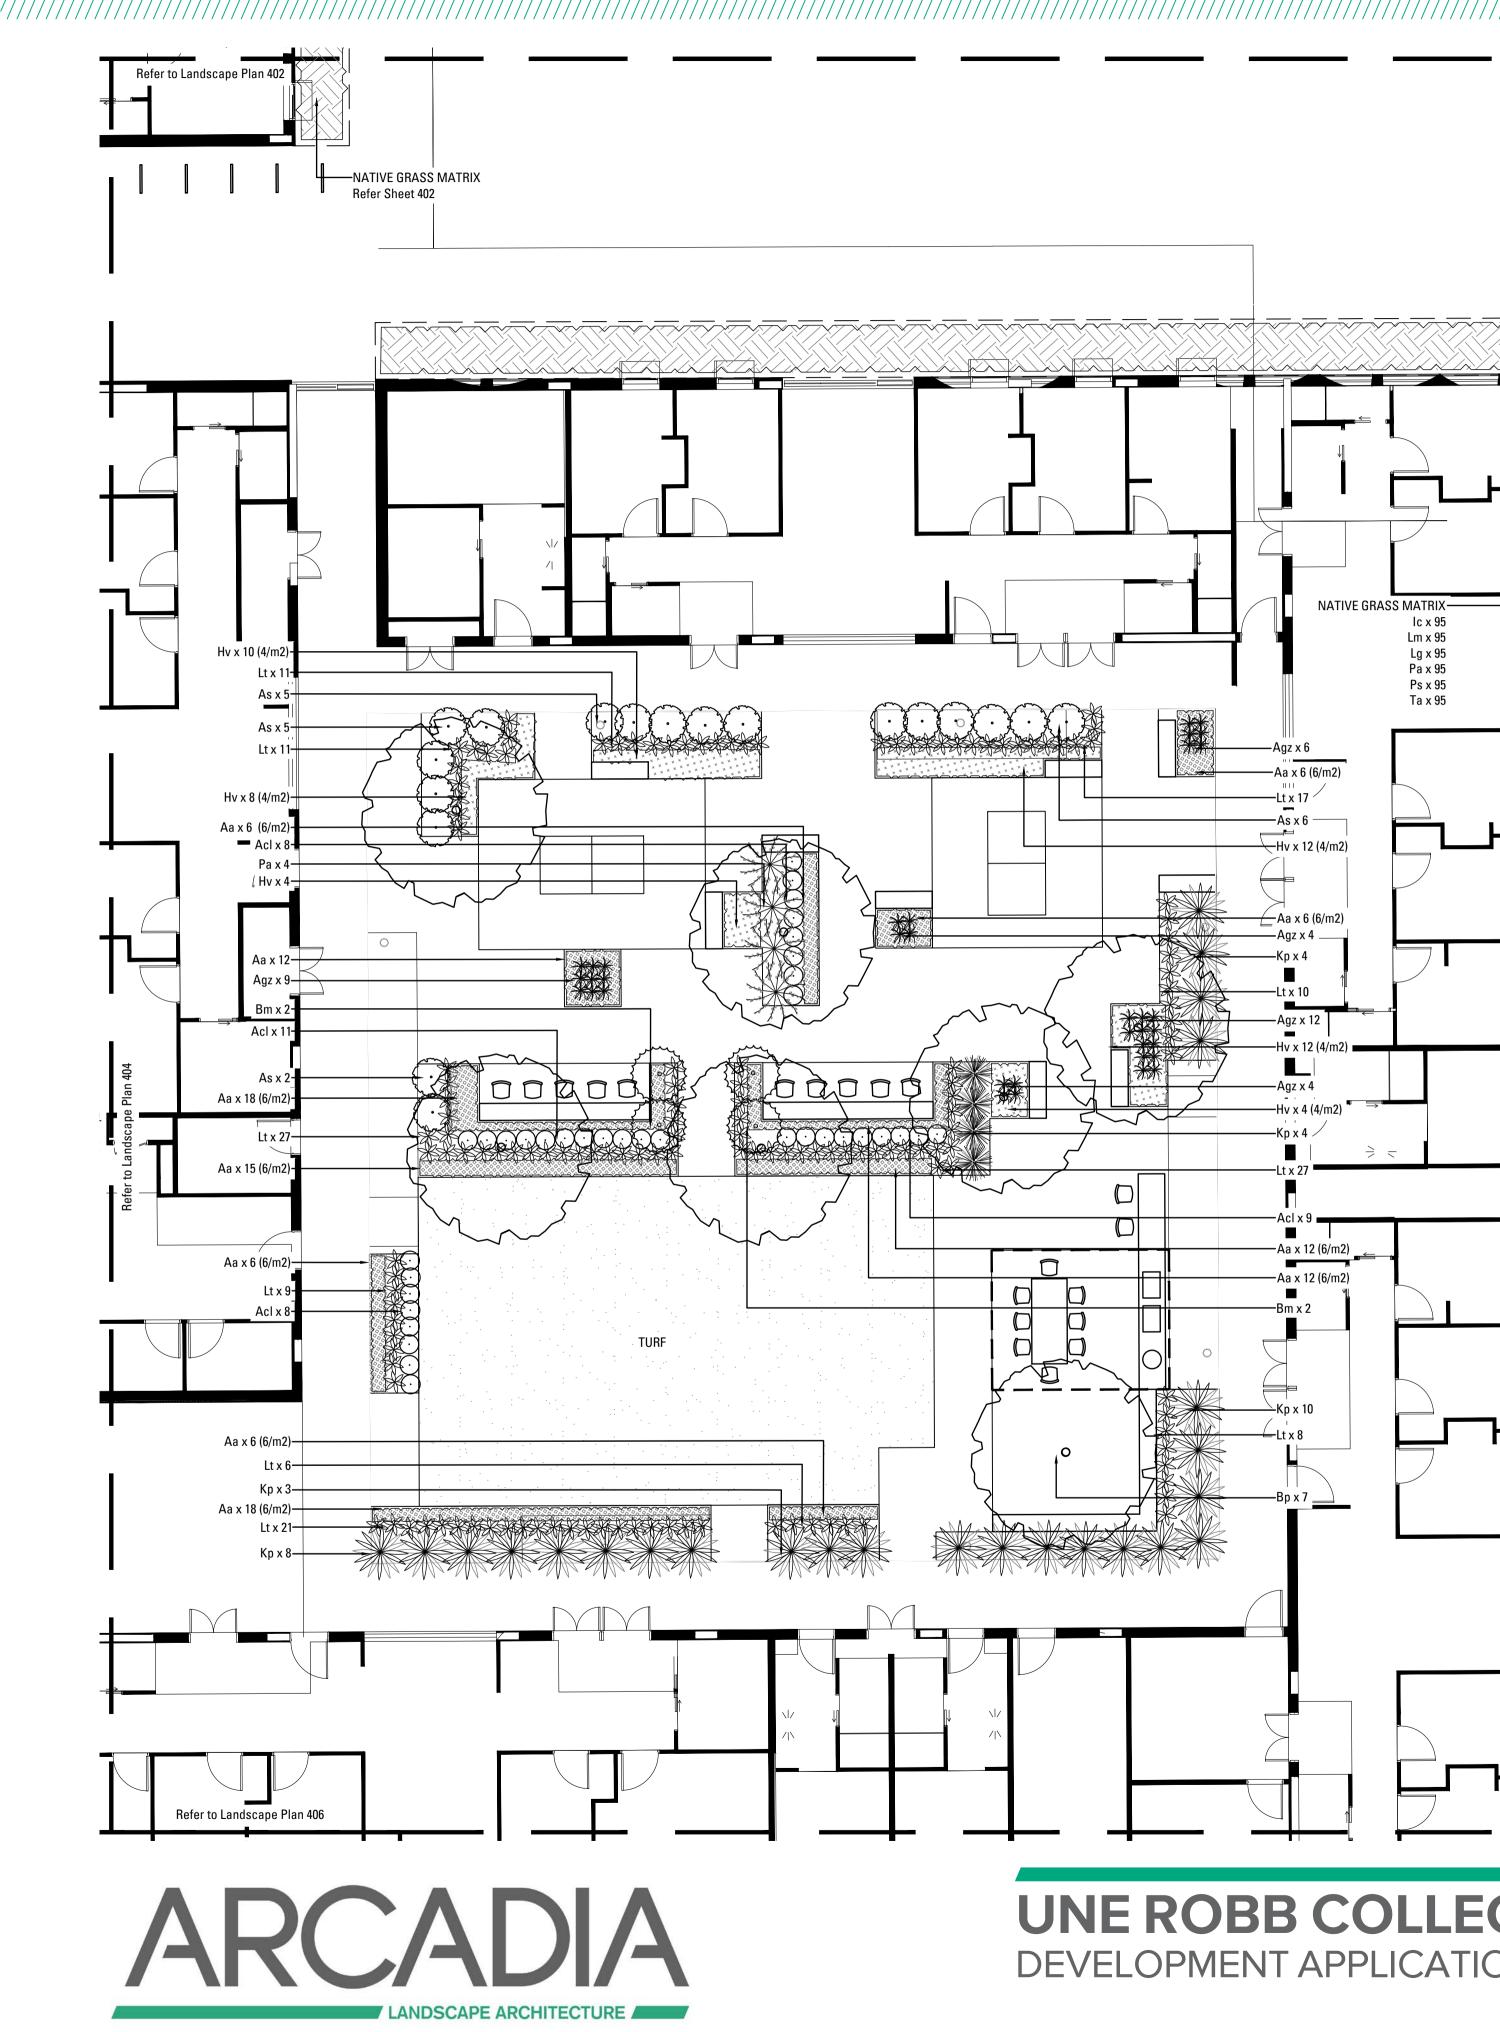




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LANDSCAPE PLAN 405



UNE ROBB COLLEGE ARMIDALE **DEVELOPMENT APPLICATION**

NATIVE GRASS MATRIX-

-Agz x 6 —Aa x 6 (6/m2)

—Lt x 17 ⁄

— As x 6 -

Hv x 12 (4/m2)

-Aa x 6 (6/m2)

-Agz x 4

-Kp x 4

Lt x 10

Agz x 12

-Agz x 4

-Kp x 4 🗸

Lt x 27

-Acl x 9 🗖

-Aa x 12 (6/m2)

–Bm x 2

Kp x 10

—Aa x 12 (6/m2)

-Hv x 4 (4/m2)

 \neq \leq

• TV X IZ (4

lc x 95 Lm x 95

Lg x 95 Pa x 95

Ps x 95


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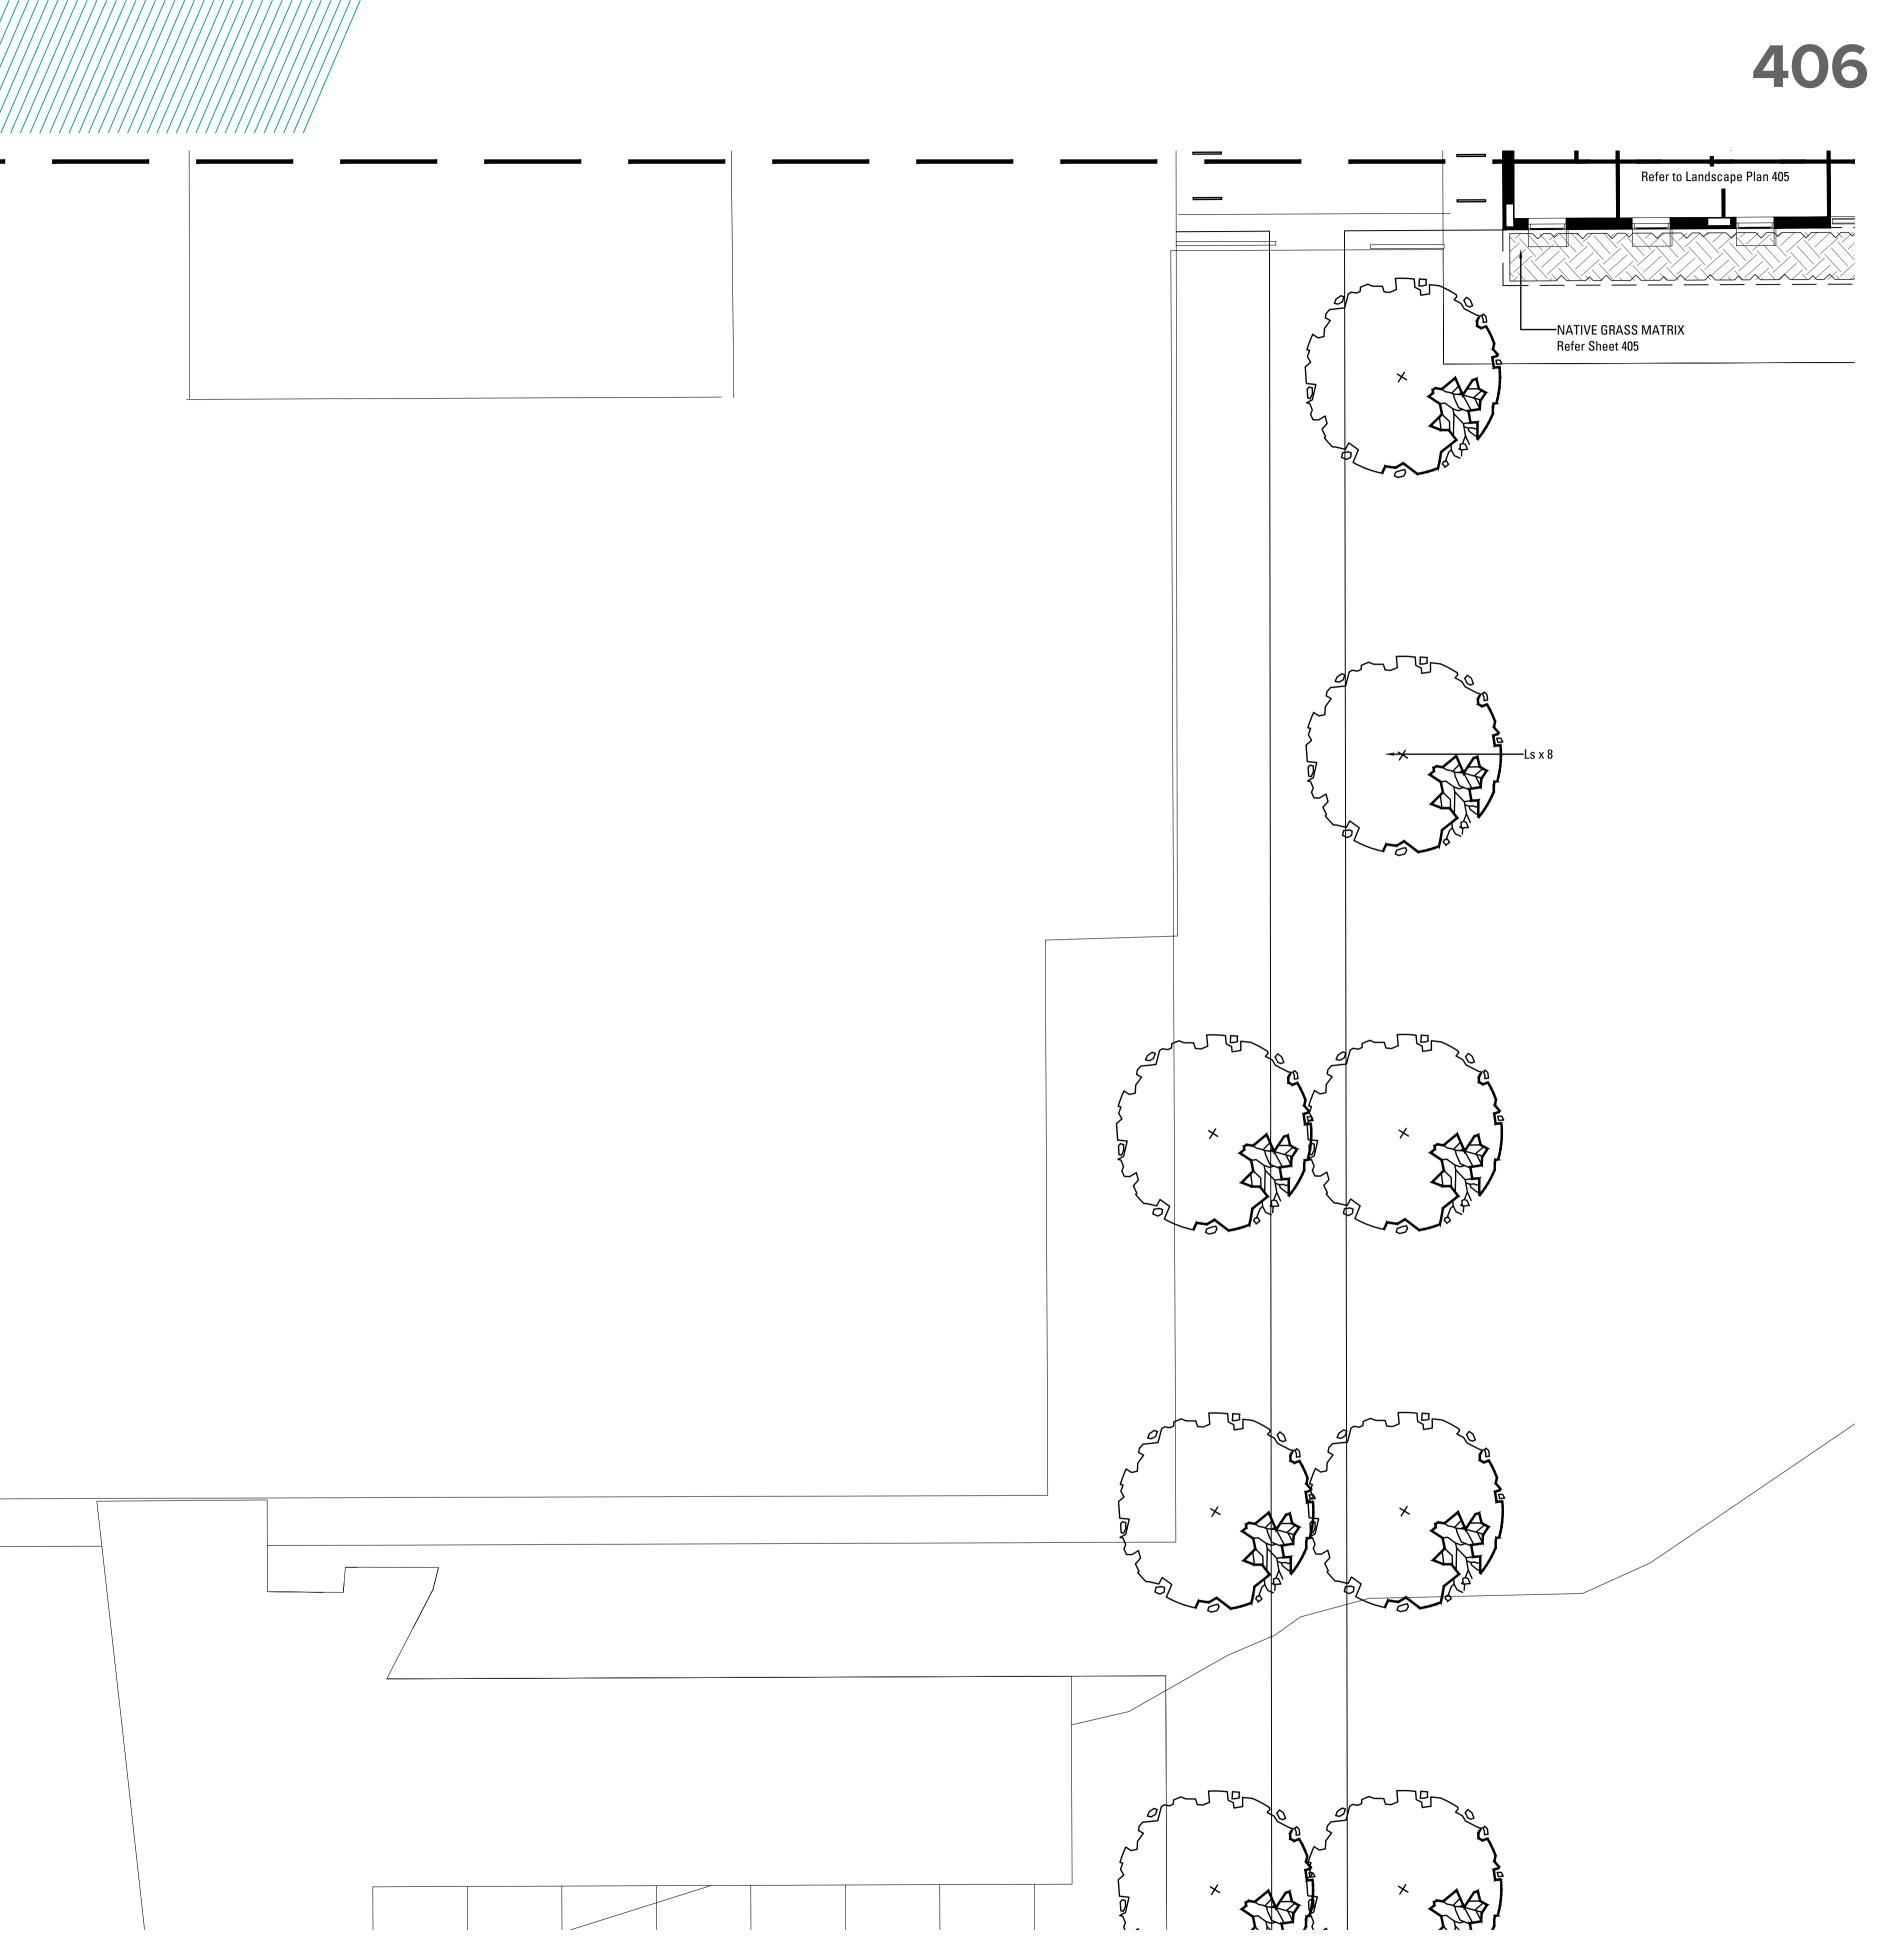
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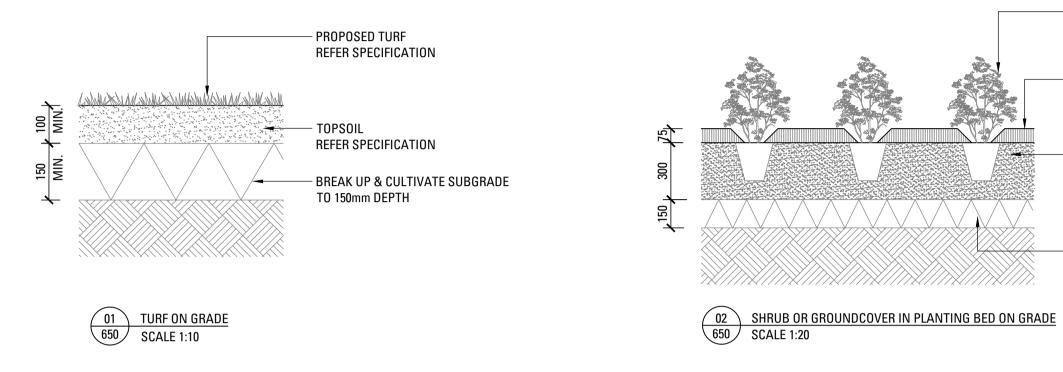
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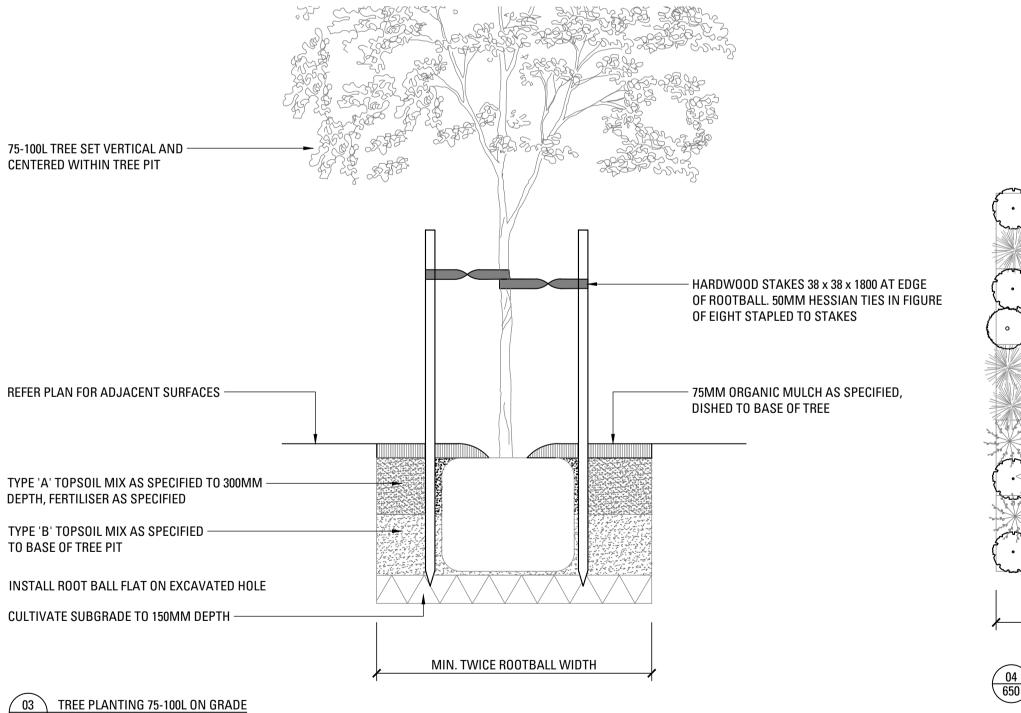
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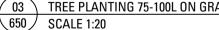
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LANDSCAPEDENALSAND/SPECIFICATION









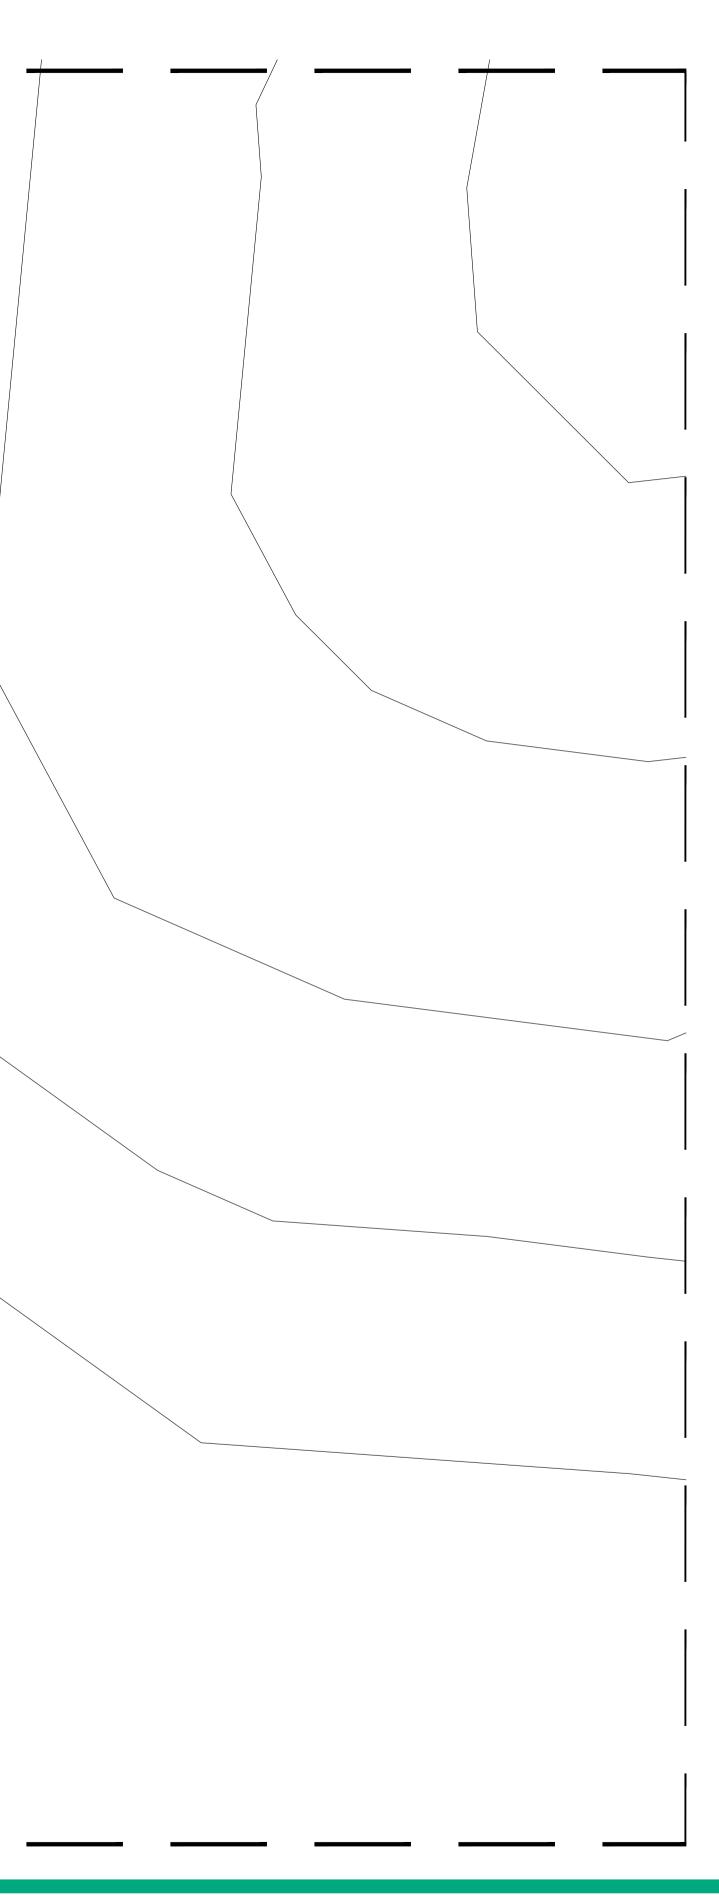




- 75mm DEPTH MULCH REFER SPECIFICATION DISHED AROUND BASE OF TRUNK

- BACKFILL & CONSOLIDATE WITH TOPSOIL MIXTURE & FERTILISE TO MIN. 300mm REFER SPECIFICATION

- BREAKUP & CULTIVATE SUBGRADE TO 150mm DEPTH

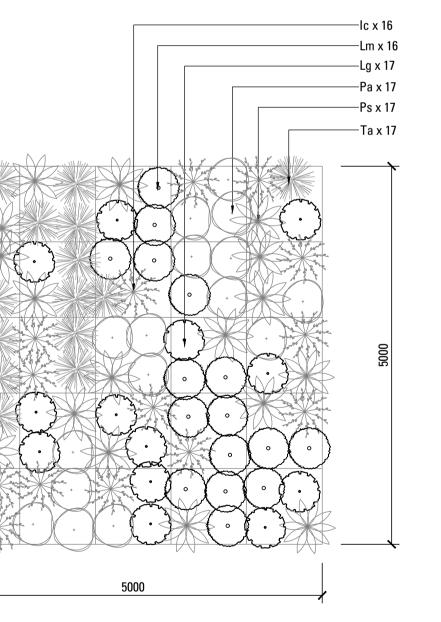

NATIVE GRASS MATRIX - 5m x 5m NOTE: DETAIL IS INDICATIVE ONLY, SCALE 1:50

PLANT ALL SPECIES RANDOMLY

LANDSCAPE SPECIFICATION NOTES

SERVICES BEFORE LANDSCAPE WORK IS COMMENCED THE LANDSCAPE CONTRACTOR IS TO ESTABLISH THE POSITION OF ALL SERVICE LINES AND ENSURE TREE PLANTING IS CARRIED OUT AT LEAST 3 METRES AWAY FROM THESE SERVICES. SERVICE LIDS, VENTS AND HYDRANTS SHALL BE LEFT EXPOSED AND NOT COVERED BY ANY LANDSCAPE FINISHES (TURFING, PAVING, GARDEN BEDS

ABORIST MANAGEMENT OF TREE PROTECTION

ETC.) FINISH ADJOINING SURFACES FLUSH WITH PIT LIDS.

A QUALIFIED AND APPROVED ABORIST IS TO BE CONTRACTED TO UNDERTAKE OR MANAGE THE INSTALLATION OF PROTECTIVE FENCING, AND TO UNDERTAKE SUCH MEASURES AS HE DEEMS APPROPRIATE TO PRESERVE THE SUBJECT TREES TO BE RETAINED. THE ARBORIST IS TO BE RETAINED FOR THE ENTIRE CONTRACT PERIOD TO UNDERTAKE ONGOING MANAGEMENT AND REVIEW OF THE TREES.

DRAINAGE CELL AND FILTER FABRIC

FOR ON-SLAB AREAS INSTALL AN APPROVED 'DRAINAGE CELL' PRODUCT TO COMPREHENSIVELY COVER THE BOTTOM OF ALL PLANTERS. OVER DRAINAGE CELL TO ON-SLAB AREAS, A POLYFELT GEOTEXTILE LINING (AS SUPPLIED BY 'POLYFELT TS' OR APPROVED EQUIVALENT) IS TO BE INSTALLED TO COVER THE BOTTOM OF ALL PLANTERS, TURNED UP 300MM AND TAPED TO THE PLANTER SIDES TO ENSURE SOIL MIX DOES NOT ESCAPE INTO DRAINAGE OUTLETS/HOLES. INSTALL MIN. 50MM COARSE RIVER SAND OVER ALL GEOTEXTILE LINING PRIOR TO INSTALLATION OF SOIL MIX.

PLANTING MIXTURE

SHALL BE HOMOGENOUS BLEND OF SOIL AND ADDITIVES IN THE FOLLOWING PROPORTIONS: EXISTING SITE SOIL IF SUITABLE OR

IMPORTED TOPSOIL 50% COMPOST 30%

D/W SAND 20%

SOIL TESTING OF EXISTING SITE SOIL IS TO BE UNDERTAKEN TO ASSESS SUITABILITY OF USE AS PLANTING TOPSOIL AND COMPLIANCE WITH AUSTRALIAN STANDARDS.

MULCH APPLICATION PLACE MULCH TO THE REQUIRED DEPTH, (REFER TO DRAWINGS) CLEAR OF PLANT STEMS, AND RAKE TO AN EVEN SURFACE FINISHING 25MM BELOW ADJOINING LEVELS. ENSURE MULCH IS WATERED IN AND TAMPED DOWN DURING INSTALLATION.

MULCH TYPE

PINE BARK: FROM MATURE TREES, GRADED IN SIZE FROM 15MM TO 30MM, FREE FROM WOOD SLIVERS. DARK BROWN IN COLOUR AND TEXTURE.

SHALL BE WELL ROTTED VEGETATIVE MATERIAL OR ANIMAL MANURE, OR OTHER APPROVED MATERIAL, FREE FROM HARMFUL CHEMICALS, GRASS AND WEED GROWTH AND WITH NEUTRAL PH. PROVIDE A CERTIFICATE OF PROOF OF PH UPON REQUEST.

ΡΙ ΔΝΤ ΜΔΤΕΒΙΔΙ

ALL PLANTS SUPPLIED ARE TO CONFORM WITH THOSE SPECIES LISTED IN THE PLANT SCHEDULE ON THE DRAWINGS. GENERALLY PLANTS SHALL BE VIGOROUS, WELL ESTABLISHED, HARDENED OFF, OF GOOD FORM CONSISTENT WITH SPECIES OR VARIETY, NOT SOFT OR FORCED, FREE FROM DISEASE OR INSECT PESTS WITH LARGE HEALTHY ROOT SYSTEMS AND NO EVIDENCE OF HAVING BEEN RESTRICTED OR DAMAGED. TREES SHALL HAVE A LEADING SHOOT. IMMEDIATELY REJECT DRIED OUT, DAMAGED OR UNHEALTHY PLANT MATERIAL BEFORE PLANTING. ALL STOCK IS TO BE CONTAINER GROWN FOR A MINIMUM OF SIX (6) MONTHS PRIOR TO DELIVERY TO SITE

FERTILISER MASS PLANTING AREAS:

FERTILISER SHALL BE 'NUTRICOTE' OR APPROVED EQUIVALENT IN GRANULE FORM INTENDED FOR SLOW RELEASE OF PLANT NUTRIENTS OVER A PERIOD OF APPROXIMATELY NINE MONTHS. THOROUGHLY MIX FERTILISER WITH PLANTING MIXTURE AT THE RECOMMENDED RATE, PRIOR TO INSTALLING PLANTS.

SHALL BE SIR WALTER BUFFALO. SHIRLEYS NO. 17 OR APPROVED EQUAL LAWN FOOD SHALL BE THOROUGHLY MIXED INTO THE TOPSOIL PRIOR TO PLACING TURF.

TREES IN GRASS AND SUPER ADVANCED TREES:

PELLETS SHALL BE IN THE FORM INTENDED TO UNIFORMLY RELEASE PLANT FOOD ELEMENTS FOR A PERIOD OF APPROXIMATELY NINE MONTHS EQUAL TO SHIRLEYS KOKEI PELLETS, ANALYSIS 6.3:1.8:2.9. KOKEI PELLETS SHALL BE PLACED AT THE TIME OF PLANTING TO THE BASE OF THE PLANT, 50MM MINIMUM FROM THE ROOT BALL AT A RATE OF TWO PELLETS PER 300MM OF TOP GROWTH TO A MAXIMUM OF 8 PELLETS PER TREE.

STAKING AND TYING STAKES SHALL BE STRAIGHT HARDWOOD, FREE FROM KNOTS AND TWISTS, POINTED AT ONE END AND

SIZED ACCORDING TO SIZE OF PLANTS TO BE STAKED.

A. 5-15 LITRE SIZE PLANT 1X(1200X25X25MM)

B 35-75 LITRE SIZE PLANT 2X(150) C. 100-GREATER THAN 200LITRE 3X(1800X50X50MM)

TIES SHALL BE 50MM WIDE HESSIAN WEBBING OR APPROVED EQUIVALENT NAILED OR STAPLED TO STAKE. DRIVE STAKES A MINIMUM ONE THIRD OF THEIR LENGTH, AVOIDING DAMAGE TO THE ROOT SYSTEM, ON THE WINDWARD SIDE OF THE PLANT.

IBBIGATION SYSTEM

SUPPLY AN AUTOMATIC WATERING SYSTEM USING 'TORO IRRIGATION SYSTEM' OR SIMILAR APPROVED, WITH MICRO-JET SPRINKLER HEADS AND LOW DENSITY, RUBBER MODIFIED POLYPROPYLENE RETICULATION, TO INCLUDE FILTERS, BENDS JUNCTIONS, ENDS AND OTHER ANCILLARY EQUIPMENT. THE LANDSCAPER SHALL NOMINATE HIS SOURCE OF SUPPLY FOR THE WATERING SYSTEM AND OBTAIN APPROVAL FROM THE SUPERINTENDENT BEFORE PLACING ORDERS FOR EQUIPMENT OR SUPPLY.

A SCHEMATIC PLAN OF THE PROPOSED IRRIGATION SYSTEM IS TO BE PREPARED BY THE CONTRACTOR, SHOWING SOLENOIDS, PIPE DIAMETERS. AND ALL NOZZLE AND TRICKLE ATTACHMENT TYPES (INCLUDING SPRAY/HEAD ANGLE), FOR REVIEW BY THE SUPERINTENDENT PRIOR TO INSTALLATION

THE CONTRACTOR IS TO LIASE WITH THE HYDRAULIC ENGINEER AND COUNCIL AS NECESSARY, TO ENSURE THE THE IRRIGATION SYSTEM CONFORMS WITH ALL THE COUNCIL AND WATER BOARD CODES AND REQUIREMENTS.

PROVIDE AN AUTOMATIC CONTROLLER THAT PROVIDES FOR TWO WEEK SCHEDULING AND HOURLY MULTI-CYCLE OPERATION. THE CONTROLLER SHALL MANUAL OVERRIDE, PROGRAMMING SHALL BE UNDERTAKEN BY THE CONTRACTOR WHO SHALL ADVISE ON THE OPERATION OF THE SYSTEM.

PROVISION OF SECURE HOUSING FOR THE AUTOMATIC IRRIGATION CONTROLLER TO BE LOCATED IN ASSOCIATION WITH THE LANDSCAPE CONTRACTOR AND LOCATION CONFIRMED BY THE SUPERINTENDENT. WIRING TO CONNECT REMOTE SOLENOID LOCATIONS IS TO BE PROVIDED. THE CONTROLLER SHALL BE LOCATED IN A DRY PLACE, PROTECTED FROM THE WEATHER, AND ALL CABLE CONNECTIONS SHALL BE MADE WITH WATERPROOF CONNECTORS.

WATER SUPPLY POINTS TO BE SUPPLIED BY BUILDER.

UNE ROBB COLLEGE ARMIDALE **DEVELOPMENT APPLICATION**

PREPA CLIEN ARCH



IT SHALL BE THE CONTRACTOR'S RESPONSIBILITY TO ENSURE AND GUARANTEE SATISFACTORY OPERATION OF THE IRRIGATION SYSTEM

AFTER THE SYSTEM HAS BEEN INSTALLED TO THE SATISFACTION OF THE SUPERINTENDENT, THE INSTALLATION SHALL BE TESTED UNDER KNOWN WORKING CONDITIONS. ACCEPTANCE OF THE INSTALLED PLANT AND EQUIPMENT SHALL BE SUBJECT TO THESE BEING SATISFACTORY.

TREATED PINE TIMBER EDGING

TIMBER EDGE: 100 X 25MM CCA TREATED RADIATA PINE TIMBER STAKES: 50 X 50 X 500MM CCA TREATED RADIATA PINE-SHARPENED AT ONE END. INSTALL IN LOCATIONS SHOWN ON THE DRAWINGS FLUSH TO FINISHED SURFACE LEVELS.

TURF ALL LANDSCAPE AREAS AS SHOWN ON THE LANDSCAPE DRAWINGS. TURF IS TO HAVE AN EVEN THICKNESS OF NOT LESS THAN 25MM. OBTAIN TURF FROM AN APPROVED GROWER. FURNISH A WARRANTY FROM THE GROWER THAT THE TURF IS FREE FROM WEEDS AND OTHER FOREIGN MATTER. DELIVER TURF TO THE SITE WITHIN 24 HOURS OF BEING CUT, AND LAY IT WITHIN 24 HOURS OF BEING DELIVERED.

TO PREPARE GRADED AREAS TO RECEIVE TURF, EXCAVATE THE AREA AND CULTIVATE SO AS TO ALLOW FOR IMPORTING OF 100MM OF TURF UNDERLAY SOIL. REMOVE ALL STONES OVER 50MM Ø AND REMOVE ALL WEEDS AND FOREIGN MATTER. SPREAD SOIL MIX A.B.S TO A DEPTH OF 100MM AND GRADE TO APPROPRIATE LEVELS TO ACHIEVE GENERAL EVEN GRADES TO DRAINAGE OUTLETS INSTALLED BY OTHERS.

LAY THE TURF ALONG THE LAND CONTOURS WITH STAGGERED, CLOSE BUTTED JOINTS, SO THAT THE FINISHED TURF SURFACE IS FLUSH WITH ADJACENT FINISHED SURFACES OF PAVING AND THE LIKE. AS SOON AS PRACTICABLE AFTER LAYING, ROLL THE TURF WITH A ROLLER WEIGHING NOT MORE THAN 90KG PER METRE OF WIDTH FOR SANDY OR LIGHT SOILS.

WATER AS NECESSARY TO KEEP THE SOIL MOIST TO A DEPTH OF 100MM. PROTECT NEWLY TURFED AREAS AGAINST TRAFFIC UNTIL GRASS IS ESTABLISHED. FERTILISE TWO WEEKS AFTER LAYING FERTILISE A.B.S

'TOP DRESS' THE TURF WHEN IT IS ESTABLISHED TO A DEPTH OF 10MM WITH COARSE WASHED RIVER SAND. RUB THE DRESSING WELL INTO THE JOINTS AND CORRECT ANY UNEVENNESS IN THE TURF SURFACES.

LANDSCAPE MAINTENANCE PROGRAM

MAINTENANCE SHALL MEAN THE CARE AND MAINTENANCE OF THE LANDSCAPE WORKS BY ACCEPTED HORTICULTURAL PRACTICE AS RECTIFYING ANY DEFECTS THAT BECOME APPARENT IN THE LANDSCAPE WORKS UNDER NORMAL USE. THIS SHALL INCLUDE, BUT SHALL NOT BE LIMITED TO, WATERING, MOWING, FERTILISING, RESEEDING, RETURFING, WEEDING, PEST AND DISEASE CONTROL, STAKING AND TYING, REPLANTING, CULTIVATION, PRUNING, AERATING, RENOVATING, TOP DRESSING, MAINTAINING THE SITE IN A NEAT AND TIDY CONDITION AS FOLLOWS:-

GENERAL

THE LANDSCAPE CONTRACTOR SHALL MAINTAIN THE LANDSCAPE WORKS FOR THE TERM OF THE MAINTENANCE (OR PLANT ESTABLISHMENT) PERIOD TO THE SATISFACTION OF THE COUNCIL. THE LANDSCAPE CONTRACTOR SHALL ATTEND TO THE SITE ON A WEEKLY BASIS. THE MAINTENANCE PERIOD SHALL COMMENCE AT PRACTICAL COMPLETION AND CONTINUE FOR A PERIOD OF TWENTY SIX (26) WEEKS.

WATERING

GRASS, TREES AND GARDEN AREAS SHALL BE WATERED REGULARLY SO AS TO ENSURE CONTINUOUS HEALTHY GROWTH.

RUBBISH REMOVAL

DURING THE TERM OF THE MAINTENANCE PERIOD THE LANDSCAPE CONTRACTOR SHALL REMOVE RUBBISH THAT MAY OCCUR AND REOCCUR THROUGHOUT THE MAINTENANCE PERIOD. THIS WORK SHALL BE CARRIED OUT REGULARLY SO THAT AT WEEKLY INTERVALS THE AREA MAY BE OBSERVED IN A COMPLETELY CLEAN AND TIDY CONDITION.

REPLACEMENTS

THE LANDSCAPE CONTRACTOR SHALL REPLACE ALL PLANTS THAT ARE MISSING, UNHEALTHY OR DEAD AT THE LANDSCAPE CONTRACTOR'S COST. REPLACEMENTS SHALL BE OF THE SAME SIZE, QUALITY AND SPECIES AS THE PLANT THAT HAS FAILED UNLESS OTHERWISE DIRECTED BY THE LANDSCAPE ARCHITECT, REPLACEMENTS SHALL BE MADE ON A CONTINUING BASIS NOT EXCEEDING TWO (2) WEEKS AFTER THE PLANT HAS DIED OR IS SEEN TO BE MISSING.

STAKES AND TIES

THE LANDSCAPE CONTRACTOR SHALL REPLACE OR ADJUST PLANT STAKES, AND TREE GUARDS AS NECESSARY OR AS DIRECTED BY THE LANDSCAPE ARCHITECT. REMOVE STAKES AND TIES AT THE END OF THE MAINTENANCE PERIOD IF SO DIRECTED.

TREES AND SHRUBS SHALL BE PRUNED AS DIRECTED BY THE LANDSCAPE ARCHITECT. PRUNING WILL BE DIRECTED AT THE MAINTENANCE OF THE DENSE FOLIAGE OR MISCELLANEOUS PRUNING AND BENEFICIAL TO THE CONDITION OF THE PLANTS. ANY DAMAGED GROWTH SHALL BE PRUNED. ALL PRUNED MATERIAL SHALL BE REMOVED FROM THE SITE.

MULCHED SURFACES

ALL MULCHED SURFACES SHALL BE MAINTAINED IN A CLEAN AND TIDY CONDITION AND BE REINSTATED IF NECESSARY TO ENSURE THAT A DEPTH OF 75MM IS MAINTAINED. ENSURE MULCH IS KEPT CLEAR OF PLANT STEMS AT ALL TIMES.

PEST AND DISEASED CONTROL

THE LANDSCAPE CONTRACTOR SHALL SPRAY AGAINST INSECT AND FUNGUS INFESTATION WITH ALL SPRAYING TO BE CARRIED OUT IN ACCORDANCE WITH THE MANUFACTURER'S DIRECTIONS. REPORT ALL INSTANCES OF PESTS AND DISEASES (IMMEDIATELY THAT THEY ARE DETECTED) TO THE LANDSCAPE ARCHITECT.

GRASS AND TURF AREAS

THE LANDSCAPE CONTRACTOR SHALL MAINTAIN ALL GRASS AND TURF AREAS BY WATERING, WEEDING, DRESSING, ROLLING, MOWING TRIMMING OR OTHER OPERATIONS AS NECESSARY, SEED AND TURE SPECIES SHALL BE THE SAME AS THE ORIGINAL SPECIFIED MIXTURE. GRASS AND TURF AREAS SHALL BE SPRAYED WITH APPROVED SELECTIVE HERBICIDE AGAINST BROAD LEAFED WEEDS AS REQUIRED BY THE LANDSCAPE ARCHITECT AND IN ACCORDANCE WITH THE MANUFACTURER'S DIRECTIONS. GRASS AND TURF AREAS SHALL BE FERTILISED ONCE A YEAR IN AUTUMN WITH "DYNAMIC LIFTER" FOR LAWNS AT A RATE OF 20KG PER 100M2. FERTILISER SHALL BE WATERED IN IMMEDIATELY AFTER APPLICATION. IRREGULARITIES IN THE GRASS AND TURF SHALL BE WATERED IN IMMEDIATELY AFTER APPLICATION. GRASS AND TURF AREAS SHALL BE KEPT MOWN TO MAINTAIN A HEALTHY AND VIGOROUS SWARD, MOWING HEIGHT: 30-50MM.

WEED ERADICATION

ERADICATE WEEDS BY ENVIRONMENTALLY ACCEPTABLE METHODS USING A NON-RESIDUAL GLYPHOSATE HERBICIDE (EG. 'ROUNDUP') IN ANY OF ITS REGISTERED FORMULAE, AT THE RECOMMENDED MAXIMUM RATE. REGULARLY REMOVE BY HAND, WEED GROWTH THAT MAY OCCUR OR RECUR THROUGHOUT GRASSED, PLANTED AND MULCHED AREAS, REMOVE WEED GROWTH FROM AN AREA 750MM DIAMETER AROUND THE BASE OF TREES IN GRASSED AREAS. CONTINUE ERADICATION THROUGHOUT THE COURSE OF THE WORKS AND DURING THE MAINTENANCE PERIOD.

SOIL SUBSIDENCE

ANY SOIL SUBSIDENCE OR EROSION WHICH MAY OCCUR AFTER THE SOIL FILLING AND PREPARATION OPERATIONS SHALL BE MADE GOOD BY THE LANDSCAPE CONTRACTOR AT NO COST TO THE CLIENT.

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Arcadia Landscape Architecture UNE Billard Leece Partnership



DATE March 2019 SCALE AS SHOWN

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